STATE OF ILLINOIS **DEPARTMENT OF TRANSPORTATION**


SECTION 21-00073-00-RS DUPAGE ILLINOIS CONTRACT NO. 61385

FOR INDEX OF SHEETS, SEE SHEET NO. 2 FOR LISTING OF HIGHWAY STANDARDS, SEE SHEET NO. 2

PLANS FOR PROPOSED FEDERAL AID HIGHWAY

FAU ROUTE 1379 (FULLERTON AVENUE) SCHMALE ROAD TO BLOOMINGDALE ROAD RESURFACING SECTION 21-00073-00-RS **PROJECT NO. 1QRB(658)** VILLAGE OF GLENDALE HEIGHTS **DUPAGE COUNTY** JOB NO. C-91-009-22

FULLERTON AVENUE FUNCTIONAL CLASSIFICATION MINOR ARTERIAL POSTED SPEED 25 M.P.H. TRAFFIC DATA ADT (YEAR) = 5900 (2020)

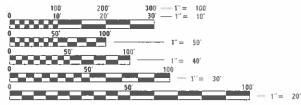


ENGINEERING SCALES. REDUCED SIZED PLANS WILL NOT CONFORM TO STANDARD SCALES. IN MAKING MEASUREMENTS ON REDUCED PLANS, THE ABOVE SCALES MAY BE USED.

JOINT UTILITY LOCATION INFORMATION FOR EXCAVATION 1-800-892-0123 OR 811

CHRISTOPHER B. BURKE ENGINEERING. LTD 9575 W. Higgins Road, Suite 600

PROFESSIONAL DESIGN FIRM NO.: 184-00175 EXPIRATION DATE: APRIL 30, 2025

CONTRACT NO. 61J85

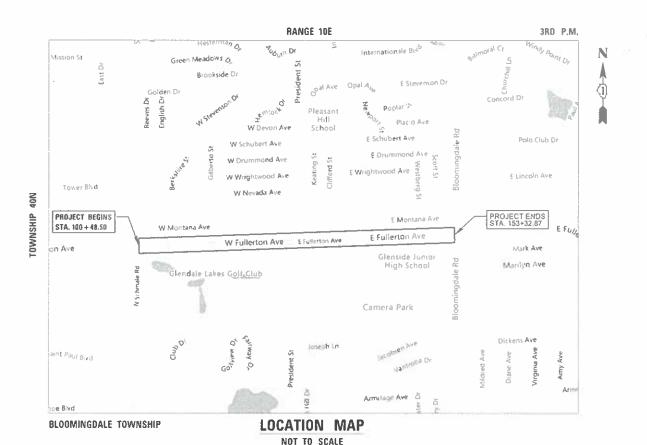

GROSS & NET LENGTH = 5,284 FT. = 1.00 MILE

BRIAN LIBUNAO ILLINOIS REGISTRATION No. 062-071040 EXPIRATION DATE: 11/30/2023

STATE OF ILLINOIS DEPARTMENT OF TRANSPORTATION Chook on Kholika MAYOR VILLAGE OF GLENDALE HEIGHTS RELEASED FOR BID

LOCATION OF SECTION INDICATED THUS: - -

PRINTED BY THE AUTHORITY OF THE STATE OF ILLINOIS

SCHAUMBURG, IL

RAMOS, P.E. (847) 705-4021 **ENGINEER: CARMEN** OFFICE AND

INDEX OF SHEETS

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HIGHWAY STANDARDS

000001-08 - STANDARD SYMBOLS, ABBREVIATIONS, AND PATTERNS

424001-11 - PERPENDICULAR CURB RAMPS FOR SIDEWALKS

424006-05 - DIAGONAL CURB RAMPS FOR SIDEWALKS

424011-04 - CORNER PARALLEL CURB RAMPS FOR SIDEWALKS

424021-06 - DEPRESSED CORNER FOR SIDEWALKS

442201-03 - CLASS C AND D PATCHES

602301-04 - INLET - TYPE A

604001-05 - FRAMES AND LIDS TYPE 1

606001-08 - CONCRETE CURB TYPE B AND COMBINATION CONCRETE CURB AND GUTTER

701006-05 - OFF RD OPERATIONS, 2L, 2W, 15' (4.5 M) TO 24" (600 mm) FROM PAVEMENT EDGE

701301-04 - LANE CLOSURE, 2L, 2W, SHORT TIME OPERATIONS

701311-03 - LANE CLOSURE 2L, 2W MOVING OPERATIONS-DAY ONLY

701501-06 - URBAN LANE CLOSURE, 2L, 2W, UNDIVIDED

701502-09 – URBAN LANE CLOSURE, 2L, 2W, WITH BIDIRECTIONAL LEFT TURN LANE

701701-10 - URBAN LANE CLOSURE, MULTILANE INTERSECTION

701801-06 - SIDEWALK, CORNER OR CROSSWALK CLOSURE

701901-08 - TRAFFIC CONTROL DEVICES

780001-05 – TYPICAL PAVEMENT MARKINGS

DISTRICT 1 STANDARD DETAILS

BD-8 - DETAILS FOR FRAMES AND LIDS ADJUSTMENT WITH MILLING

BD-22 - PAVEMENT PATCHING FOR HMA SURFACED PAVEMENT

BD-24 – CURB OR CURB AND GUTTER REMOVAL AND REPLACEMENT

BD-32 – BUTT JOINT AND HMA TAPER DETAILS

 ${\sf TC-10-TRAFFIC\ CONTROL\ AND\ PROTECTION\ FOR\ SIDE\ ROADS,\ INTERSECTIONS,\ AND\ DRIVEWAYS}$

TC-13 – DISTRICT ONE TYPICAL PAVEMENT MARKINGSSHORT TERM PAVEMENT MARKING LETTERS AND SYMBOLS

TC-16 - SHORT TERM PAVEMENT MARKING LETTERS AND SYMBOLS

TC-22 – ARTERIAL ROAD INFORMATION SIGN

TS-07 – DISTRICT 1 – DETECTOR LOOP INSTALLATION DETAILS FOR ROADWAY RESURFACING

COMMITMENTS

NO PARKING WILL BE ALLOWED ON W. FULLERTON AVENUE WITHIN THE PROJECT LIMITS THROUGHOUT CONSTRUCTION.

FILE NAME =	USER NAME = blibunao	DESIGNED - BRL	REVISED =		FULLERTON AVENUE RESURFACING	F.A.U.	SECTION	COUNTY TOTAL	SHEET
N:\GLENDALEHEIGHTS\040051D208\C1v1\IND	X_D2Ø8.SHT	DRAWN - BRL	REVISED -	STATE OF ILLINOIS	INDEX OF SHEETS, HIGHWAY STANDARDS,	1379	21-00073-00-RS	DUPAGE 40	2
	PLOT SCALE 3 NOT TO SCALE	CHECKED = AMP	REVISED =	DEPARTMENT OF TRANSPORTATION	D1 STANDARDS & COMMITTMENTS			CONTRACT NO. 6	1J85
	PLOT DATE = 9/13/2023	DATE 9/13/2023	REVISED =		SCALE: N.T.S. SHEET NO. 2 OF 40 SHEETS STA. TO STA.		ILLINOIS FED. A	ID PROJECT	

GENERAL NOTES

SPECIFICATIONS, STANDARDS AND SPECIAL PROVISIONS

- 1. ALL CONSTRUCTION SHALL BE DONE IN ACCORDANCE WITH THE "STANDARD SPECIFICATIONS FOR ROAD AND BRIDGE CONSTRUCTION", ADOPTED JANUARY 1, 2022; THE "SUPPLEMENTAL SPECIFICATIONS AND RECURRING SPECIAL PROVISIONS", ADOPTED JANUARY 1, 2023; REVISION 3, NOVEMBER 2021 OF THE "ILLINOIS MANUAL ON UNIFORM TRAFFIC CONTROL DEVICES FOR STREETS AND HIGHWAYS" (IMUTCD) AND "THE STANDARD SPECIFICATIONS FOR WATER AND SEWER MAIN CONSTRUCTION IN ILLINOIS" EIGTH EDITION; THE "DETAILS" IN THE PLANS; AND THE "SPECIAL PROVISIONS" INCLUDED IN THE CONTRACT DOCUMENTS.
- 2. ANY REFERENCE TO STANDARDS THROUGHOUT THE PLANS OR SPECIAL PROVISIONS SHALL BE INTERPRETED AS THE LATEST IDOT STANDARD.
- ALL TRAFFIC CONTROL AND OTHER ADVISORY SIGNS NEEDED FOR CONSTRUCTION ARE TO BE FURNISHED BY THE CONTRACTOR IN ACCORDANCE WITH SECTION 700 OF THE STANDARD SPECIFICATIONS.

UTILITIES

- 4. THE CONTRACTOR SHALL BE RESPONSIBLE FOR CONTACTING THE OWNERS OF ALL EXISTING FACILITIES SO THAT THE UTILITIES AND THEIR APPURTENANCES MAY BE LOCATED AND ADJUSTED OR MOVED, IF NECESSARY, PRIOR TO THE START OF CONSTRUCTION OPERATIONS. THE CONTRACTOR SHALL COOPERATE WITH ALL UTILITY OWNERS AS PROVIDED FOR IN THE STANDARD SPECIFICATIONS.
- 5. THE LOCATIONS OF EXISTING DRAINAGE STRUCTURES, STORM AND SANITARY SEWERS, WATER SERVICE LINES AND OTHER UTILITY LINES ARE APPROXIMATE, AND THE VILLAGE AND ENGINEER DO NOT GUARANTEE THEIR ACCURACY. THEIR EXACT HORIZONTAL AND VERTICAL LOCATIONS ARE TO BE DETERMINED IN THE FIELD BY THE CONTRACTOR.
- 6. THE CONTRACTOR SHALL BE RESPONSIBLE FOR THE PROTECTION OF ALL UNDERGROUND OR SURFACE UTILITIES EVEN THOUGH THEY MAY NOT BE SHOWN ON THE PLANS. ANY UTILITY THAT IS DAMAGED DURING CONSTRUCTION SHALL BE REPAIRED OR REPLACED TO THE SATISFACTION OF THE ENGINEER.
- 7. BEFORE STARTING ANY EXCAVATION, THE CONTRACTOR SHALL CALL "JULIE" AT 8-1-1 FOR FIELD LOCATIONS OF BURIED ELECTRIC, TELEPHONE, GAS AND CABLE TELEVISION FACILITIES (48 HOURS NOTIFICATIONS IS REQUIRED).
- 8. THE CONTRACTOR SHALL CONTACT IDOT'S BUREAU OF MATERIALS (PHONE 847-705-4337) AT LEAST 24 HOURS BEFORE PLACING HOT MIX ASPHALT OR PORTLAND CEMENT CONCRETE.

STORM SEWER AND SANITARY SEWER

- 9. WHENEVER DURING CONSTRUCTION OPERATIONS ANY LOOSE MATERIAL IS DEPOSITED IN THE FLOW LINE OF DRAINAGE STRUCTURES SUCH THAT THE NATURAL FLOW OF WATER IS OBSTRUCTED, IT SHALL BE REMOVED AT THE CLOSE OF EACH WORKING DAY. AT THE CONCLUSION OF CONSTRUCTION OPERATIONS, ALL UTILITY STRUCTURES SHALL BE FREE FROM DIRT AND DEBRIS. THE WORK SPECIFIED ABOVE SHALL BE COMPLETED PER ARTICLE 107.15 OF THE STANDARD SPECIFICATIONS.
- 10. WHEN EXISTING DRAINAGE FACILITIES ARE DISTURBED, THE CONTRACTOR SHALL PROVIDE AND MAINTAIN TEMPORARY OUTLETS AND CONNECTIONS FOR ALL PRIVATE OR PUBLIC DRAINS, SEWERS OR CATCH BASINS. HE/SHE SHALL PROVIDE FACILITIES TO TAKE IN ALL STORM WATER WHICH WILL BE RECEIVED BY THESE DRAINS AND SEWERS AND DISCHARGE THE SAME. HE/SHE SHALL PROVIDE AND MAINTAIN AN EFFICIENT PUMPING PLAN, IF NECESSARY, AND A TEMPORARY OUTLET AND BE PREPARED AT ALL TIMES TO DISPOSE OF THE WATER RECEIVED FROM THESE TEMPORARY CONNECTIONS UNTIL SUCH TIME AS THE PERMANENT CONNECTIONS WITH SEWERS ARE BUILT AND IN SERVICE.

- 11. ALL EXISTING OR PROPOSED STORM SEWER DAMAGED BY THE CONTRACTOR DURING CONSTRUCTION SHALL BE REPLACED BY THE CONTRACTOR.
- 12. STRUCTURE ADJUSTMENTS: PRECAST CONCRETE ADJUSTMENT RINGS ARE NOT TO EXCEED 12 INCHES IN OVERALL HEIGHT AND SHALL BE USED IF AN ADJUSTMENT TO THE FINISHED GRADE ESTABLISHED BY THE PROJECT ENGINEER IS NECESSARY. MAXIMUM TWO RINGS.
- 13. THE CONTRACTOR SHALL CONFIRM ALL EXISTING STORM SEWER PIPE SIZES AND INVERTS PRIOR TO ORDERING STRUCTURES. ANY MODIFICATIONS OF STRUCTURES DUE TO THE FAILURE OF THE CONTRACTOR TO PERFORM THIS TASK MAY LED TO THE REJECTION OF THE STRUCTURE IN THE FIELD.
- 14. THE CONTRACTOR SHALL NOT OPEN OR SHUT ANY WATER VALVES OR FIRE HYDRANTS WITHOUT PRIOR AUTHORIZATION FROM THE VILLAGE WATER DEPARTMENT. UNAUTHORIZED USE SHALL SUBJECT THE OFFENDER TO ARREST AND PROSECUTION.

MISCELLANEOUS

- 15. ACCESS: THE CONTRACTOR SHALL PROVIDE ACCESS TO ABUTTING PROPERTY AT ALL TIMES DURING THE CONSTRUCTION OF THIS PROJECT, EXCEPT FOR PERIODS OF SHORT DURATION.
- 16. DIMENSIONS: THE CONTRACTOR SHALL VERIFY ALL DIMENSIONS AND CONDITIONS EXISTING IN THE FIELD PRIOR TO ORDERING MATERIALS AND BEGINNING CONSTRUCTION.
- 17. LIMITS OF PATCHING, CURB AND GUTTER REMOVAL AND REPLACEMENT, SIDEWALK REMOVAL AND REPLACEMENT, DRIVEWAY REMOVAL AND REPLACEMENT AND STRUCTURES TO BE ADJUSTED WILL BE DETERMINED BY THE ENGINEER IN THE FIELD.
- 18. THE THICKNESSES OF HOT-MIX ASPHALT MIXTURES SHOWN IN THE PLANS ARE NOMINAL. DEVIATIONS MAY OCCUR DUE TO IRREGULARITIES IN THE SURFACES OR BASES ON WHICH THEY ARE TO BE PLACED.
- 19. DEPRESSED CURB: RAMPS AND DEPRESSED CURBS ACCESSIBLE TO THE HANDICAPPED SHALL BE PROVIDED AT ALL CROSSWALKS. THE TRANSITION FROM DEPRESSED TO FULL HEIGHT SHALL BE 6' LONG WHERE THERE IS SIDEWALK ADJACENT TO BACK OF CURB.
- 20. DETECTABLE WARNINGS FOR THE HANDICAPPED SHALL BE INSTALLED AT ALL INTERSECTING STREETS, DRIVEWAYS, AND ALLEYS AS SHOWN ON THE PLANS.
- 21. ALL UNDERGROUND, DRIVEWAY, CONCRETE, AND LANDSCAPE RESTORATION WORK IS TO BE COMPLETED BEFORE THE SURFACE COURSE CAN BE INSTALLED.
- 22. FOR HOT-MIX ASPHALT SURFACE REMOVAL, THE EXISTING ASPHALT SURFACE SHALL BE REMOVED TO THE DEPTH SPECIFIED. THE GRINDINGS SHALL BE REMOVED FROM THE SITE AND THE SURFACE MECHANICALLY BROOMED UNTIL THE SURFACE IS COMPLETELY FREE OF ANY LOOSE MATERIAL AND DEBRIS.
- 23. NO CONSTRUCTION SHALL BEGIN UNTIL ALL PROPER TEMPORARY SIGNS AND BARRICADES HAVE BEEN INSTALLED.
- 24. THE CONTRACTOR SHALL BE SOLELY RESPONSIBLE FOR JOB SITE SAFETY AS WELL AS SUPERVISION/DIRECTION AND MEANS/METHODS OF CONSTRUCTION.

- 25. BEFORE BEGINNING CONSTRUCTION, THE CONTRACTOR SHALL VERIFY THE LINE AND GRADES SHOWN ON THE CONTRACT DRAWINGS. IF THERE ARE ANY DISCREPANCIES FROM WHAT IS SHOWN ON THE CONTRACT DRAWINGS, THE CONTRACTOR SHALL IMMEDIATELY REPORT SAME TO THE ENGINEER PRIOR TO PERFORMING WORK. CONTRACTOR SHALL BE RESPONSIBLE FOR COORDINATION OF WORK AS REQUIRED.
- 26. SOIL EROSION PROTECTION SHALL BE IN ACCORDANCE WITH IEPA STANDARDS AND SPECIFICATIONS FOR SOIL EROSION AND SEDIMENT CONTROL. ALL DISTURBED AREAS (NOT IMPERVIOUS IN NATURE) SHALL BE FINE GRADED, TOP SOIL RESTORED (MIN 4 INCHES) AND SOD APPLIED UNLESS OTHERWISE SPECIFIED ON THE PLANS.
- 27. ALL SAW CUTTING SHALL BE PERFORMED PRIOR TO BEGINNING REMOVAL. ANY ITEMS OF WORK REMOVED PRIOR TO SAWCUTTING WILL NOT BE MEASURED FOR PAYMENT.
- 28. THE CONTRACTOR SHALL KEEP ONE LANE IN EACH DIRECTION OPEN TO TRAFFIC AT ALL TIMES DURING CONSTRUCTION. THE CONTRACTOR SHALL COMPLETE ALL MILLING OPERATIONS BEFORE INSTALLING ANY HOT-MIX ASPHALT PAVEMENT.
- 29. ALL TRAFFIC SIGNAL MODIFICATIONS/DETECTOR LOOP REPLACEMENT MUST BE PERFORMED BY AN IDOT PRE-QUALIFIED ELECTRICAL CONTRACTOR.
- 30. THE TRAFFIC SIGNAL DETECTOR LOOPS ON FULLERTON AVENUE AT SCHMALE ROAD (EAST LEG) AND FULLERTON AVENUE AT THE BLOOMINGDALE ROAD INTERSECTION (WEST LEG) MUST BE INSTALLED IN THE HMA BINDER COURSE BY AN IDOT DISTRICT 1 PRE-QUALIFIED ELECTRICAL CONTRACTOR.
- 31. THE ELECTRICAL CONTRACTOR MUST SUBMIT A CATALOG CUT OF THE TRAFFIC SIGNAL DETECTOR WIRE AND SEALANT TO THE COUNTY FOR REVIEW/APPROVAL PRIOR TO THE INSTALLATIONS VIA EMAIL: MARYANNE.SIOSON@DUPAGECO.ORG.
- 32. THE CONTRACTOR MUST PROVIDE AND MAINTAIN SUFFICIENT WASHROOMS FOR THE PROJECT.
- 33. ADVANCE WARNING SIGNS NEED TO BE ERECTED AT LEAST 7 DAYS PRIOR TO START OF CONSTRUCTION
- 34. PRIOR TO INSTALLING SURFACE COURSE AND AT THE ENGINEER'S DISCRETION, THE CONTRACTOR SHALL SAWCUT THE EXISTING PAVEMENT TO PROVIDE A NEW BUTT JOINT TO PAVE AGAINST.
- 35. ANY DEFACED WORK SHALL BE CORRECTED OR REPLACED BY THE CONTRACTOR. THE VILLAGE WILL COOPERATE WITH THE CONTRACTOR TO MINIMIZE VANDALISM, BUT THE CONTRACTOR SHALL BE ULTIMATELY RESPONSIBLE TO CORRECT ANY DAMAGE PER CONDITIONS OF ARTICLE 107.30 OF THE STANDARD SPECIFICATIONS.
- 36. THE CONTRACTOR SHALL TAKE PRECAUTION BY PRESERVING EXISTING TREES WITHIN RIGHT OF WAY. IF ANY DAMAGE OCCURS, TREES SHALL BE REPLACED IN KIND PER ARTICLE 201.07 REPAIR OR REPLACEMENT OF EXISTING PLANT MATERIAL REQUIREMENTS STATED HEREIN.
- 37. THE CONTRACTOR SHALL CONTACT KALPANA HOSADURGA, THE DISTRICT ONE TRAFFIC CONTROL SUPERVISOR AT KALPANA.KANNAN-HOSADURGA@ILLINOIS.GOV A MINIMUM OF 72-HOURS IN ADVANCE OF BEGINNING WORK.
- 38. PLEASE CONTACT MS. MARYANNE SIOSON, DUPAGE COUNTY'S TRAFFIC SIGNAL ENGINEER AT (630) 407-6908 A MINIMUM OF 48 HOURS IN ADVANCE TO INSPECT THE TRAFFIC SIGNAL DETECTOR LOOP LAYOUT PRIOR TO INSTALLATIONS.
- 39. A PRE-CONSTRUCTION VIDEO WILL BE PREFORMED PRIOR TO THE START OF CONSTURCTION BY THE ENGINEER TO DOCUMENT THE EXISTING CONDITIONS.

FILE NAME =	USER NAME = blibunao	DESIGNED	-	BRL	REVISED	-
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	PLOT SCALE = NOT TO SCALE	CHECKED	-	AMP	REVISED	-
	PLOT DATE = 9/1/2023	DATE	-	9/1/2023	REVISED	-

	FUNDING SOURCE				STP 60% FED 40% LOCAL			
	CONSTRUCTION TYPE CODE			0005	0005 0042			
CODE NO.	ITEM	UNIT	TOTAL QUANTITY	ROADWAY	TRAINEES	NON- PARTICIPATING		
20101100	TREE TRUNK PROTECTION	EACH	35	35				
20101200	TREE ROOT PRUNING	EACH	31	31		A		
20101300	TREE PRUNING (1 TO 10 INCH DIAMETER)	EACH	6	6				
20101350	TREE PRUNING (OVER 10 INCH DIAMETER)	EACH	12	12				
20201200	REMOVAL AND DISPOSAL OF UNSUITABLE MATERIAL	CU YD	425	425				
20800150	TRENCH BACKFILL	CU YD	160	160				
21001000	GEOTECHNICAL FABRIC FOR GROUND STABILIZATION	SQ YD	2,340	2,340				
21101615	TOPSOIL FURNISH AND PLACE, 4"	SQ YD	915	915				
21101630	TOPSOIL FURNISH AND PLACE, 8"	SQ YD	75	75				
25200110	SODDING, SALT TOLERANT	SQ YD	920	920				
25200200	SUPPLEMENTAL WATERING	UNIT	50	50				
28000250	TEMPORARY EROSION CONTROL SEEDING	POUND	25	25				
28001100	TEMPORARY EROSION CONTROL BLANKET	SQ YD	75	75				
28000510	INLET FILTERS	EACH	71	71				
30300001	AGGREGATE SUBGRADE IMPROVEMENT	CU YD	390	390				
40600290	BITUMINOUS MATERIALS (TACK COAT)	POUND	15,845	15,845				
40600400	MIXTURE FOR CRACKS, JOINTS, AND FLANGEWAYS	TON	50	50				
40600982	HOT-MIX ASPHALT SURFACE REMOVAL - BUTT JOINT	SQ YD	205	205				
40603080	HOT-MIX ASPHALT BINDER COURSE, IL-19.0, N50	TON	3,290	3,290				
40604060	HOT-MIX ASPHALT SURFACE COURSE, IL-9.5, MIX "D", N50	TON	1,975	1,975				

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SUMMARY OF QUANTI	TIES	F.A.U. RTE. 1379	21-00073-00-RS	COUNTY DUPAGE	TOTAL SHEETS 40	SHEE NO.
				CONTRAC		61J85
SCALE: N.T.S. SHEET NO. 4 OF 40 SHEETS STA	TO STA.		ILLINOIS FED. A	D PROJECT		

		FUNDING SOURCE				STP 60% FED 40% LOCAL	
		CONSTRUCTION TYPE CODE			0005	0042	0021
	CODE NO.	ITEM	UNIT	TOTAL QUANTITY	ROADWAY	ROADWAY TRAINEES	
	42400200	PORTLAND CEMENT CONCRETE SIDEWALK 5 INCH	SQ FT	29,590	8,455		PARTICIPATING 21,135
	44000100	PAVEMENT REMOVAL	SQ YD	70	70		
	42400800	DETECTABLE WARNINGS	SQ FT	170	170		
	44000165	HOT-MIX ASPHALT SURFACE REMOVAL, 4"	SQ YD	23,470	23,470		
	44000500	COMBINATION CURB AND GUTTER REMOVAL	FOOT	130	130		
	44000600	SIDEWALK REMOVAL	SQFT	30,295	9,160		21,135
	44003100	MEDIAN REMOVAL	SQ FT	310	310		
	44201737	CLASS D PATCHES, TYPE I, 8 INCH	SQ YD	585	585		
	44201741	CLASS D PATCHES, TYPE II, 8 INCH	SQ YD				
				585	585		
	44201745	CLASS D PATCHES, TYPE III, 8 INCH	SQ YD	585	585		
	44201747	CLASS D PATCHES, TYPE IV, 8 INCH	SQ YD	585	585		
	550A0050	STORM SEWERS, CLASS A, TYPE 1 12"	FOOT	245	245		
	550A0070	STORM SEWERS, CLASS A, TYPE 1 15"	FOOT	35	35		
	550A0090	STORM SEWERS, CLASS A, TYPE 1 18"	FOOT	5	5		
	55100500	STORM SEWER REMOVAL 12"	FOOT	245	245		
\coprod	55100700	STORM SEWER REMOVAL 15"	FOOT	35	35		
	55100900	STORM SEWER REMOVAL 18"	FOOT	5	5		
	60603800	COMBINATION CONCRETE CURB AND GUTTER, TYPE B-6.12	FOOT	155	155		
	60600605	CONCRETE CURB, TYPE B	FOOT	155	155		
	60618300	CONCRETE MEDIAN SURFACE, 4 INCH	SQ FT	310	310		
++	222,000		931	010			

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	SU	MM/	\KY	OF QU	ANTITIES		1379	21-00073-00-RS	DUPAGE	40	5	
									CONTRAC	T NO.	61,38	
SCALE: N.T.S.	SHEET NO. 5	OF	40	SHEETS	STA.	TO STA.		ILLINOIS FED. A	ID PROJECT			_


		FUNDING SOURCE				STP 60% FED 40% LOCAL	
		CONSTRUCTION TYPE CODE			0005	0021	
1	CODE NO.	ITEM	UNIT	TOTAL QUANTITY	ROADWAY	TRAINEES	NON- PARTICIPATING
~	66900200	NON-SPECIAL WASTE DISPOSAL	CU YD	25	25		
~	66900530	SOIL DISPOSAL ANALYSIS	EACH	1	1		
~	66901001	REGULATED SUBSTANCES PRE-CONSTRUCTION PLAN	L SUM	1	1		
~	66901003	REGULATED SUBSTANCES FINAL CONSTRUCTION REPORT	L SUM	1	1		
~	66901006	REGULATED SUBSTANCES MONITORING	CAL DA	30	30		
	67100100	MOBILIZATION	L SUM	1	4		
	70102620	TRAFFIC CONTROL AND PROTECTION, STANDARD 701501	L SUM				
				1	1		
	70102622	TRAFFIC CONTROL AND PROTECTION, STANDARD 701502	L SUM	1	1		
	70102635	TRAFFIC CONTROL AND PROTECTION, STANDARD 701701	L SUM	1	1	***************************************	
	70102640	TRAFFIC CONTROL AND PROTECTION, STANDARD 701801	L SUM	1	1		
	70300100	SHORT TERM PAVEMENT MARKING	FOOT	2,475	2475		
	70300150	SHORT TERM PAVEMENT MARKING REMOVAL	SQFT	300	300		
~	78000100	THERMOPLASTIC PAVEMENT MARKING - LETTERS AND SYMBOLS	SQFT	415	415		
-	78000200	THERMOPLASTIC PAVEMENT MARKING - LINE 4"	FOOT	9,780	9,780		
~	78000400	THERMOPLASTIC PAVEMENT MARKING - LINE 6"	FOOT	1,925	1,925		
	78000600	THERMOPLASTIC PAVEMENT MARKING - LINE 12"	FOOT	1,305			
					1,305		
~	78000650	THERMOPLASTIC PAVEMENT MARKING - LINE 24"	FOOT	285	285		name)
~	85000200	MAINTENANCE OF EXISTING TRAFFIC SIGNAL INSTALLATION	EACH	2	2		
	X0323677	STREET SWEEPING	HOUR	8	8		
	X4021000	TEMPORARY ACCESS (PRIVATE ENTRANCE)	EACH	101	101		


1	FILE NAME 1	USER NAME = blibuneo	DESIGNED -	BRL.	REVISED -					F.A.U.	SECTION	COUNTY	TOTAL :
	MINS: ENDALEHEIGHTSNØ400510208NC:v:1NS00	CZCO-3.SNT	DRAWN -	BRL	REVISED -	STATE OF ILLINOIS		SUMMARY OF QUAN	TITIES	1379	21-00073-00-RS	DUPAGE	40
- 1		PLOT SCALE = NOT TO SCALE	CHECKED	AMP	REVISEO	DEPARTMENT OF TRANSPORTATION						CONTRAC	CT NO. 6
		PLG EATE = 9/13/2023	DATE -	9/13/2023	REVISED -		SCALE: N.T.S.	SHEET NO. 6 OF 40 SHEETS S	TA. TO STA.	[ILLINOIS FED. AI	D PROJECT	

CODE NO.	CONSTRUCTION TYPE CODE				40% LOCAL	
CODE NO.	ONOTION THE CODE			0005	0042	0021
	ITEM	UNIT	TOTAL QUANTITY	ROADWAY	TRAINEES	NON- PARTICIPATING
X4022000	TEMPORARY ACCESS (COMMERCIAL ENTRANCE)	EACH	8	8		
X4023000	TEMPORARY ACCESS (ROAD)	EACH	8	8		
X4400501	COMBINATION CONCRETE CURB AND GUTTER REMOVAL AND REPLACEMENT LESS THAN OR EQUAL TO 10 FEET	FOOT	215	215		
X4400503	COMBINATION CONCRETE CURB AND GUTTER REMOVAL AND REPLACEMENT GREATER THAN 10 FEET	FOOT	980	980		had 20010 2000 2000 2000 2000 2000 2000 20
X6020710	CATCH BASINS TO BE ADJUSTED WITH SPECIAL FRAME AND GRATE	EACH	66	66		
X6023508	INLETS, TYPE A, WITH SPECIAL FRAME AND GRATE	EACH	1	1		AREA MURANESANI MURAN TO THE TOTAL MARKET MA
X8860105	DETECTOR LOOP REPLACEMENT	FOOT	1,185	1185		
XX002260	STRUCTURES TO BE REMOVED	EACH	1	1		
XX003435	PORTLAND CEMENT CONCRETE DRIVEWAY REMOVAL AND REPLACEMENT	SQ YD	565	565		
XX006429	SIDEWALK, SPECIAL	SQ FT	500	500		
XX006947	HOT-MIX ASPHALT DRIVEWAY REMOVAL AND REPLACEMENT	SQ YD	250	250		
Z0013798	CONSTRUCTION LAYOUT	LSUM	1	1		
Z0017400	DRAINAGE & UTILITY STRUCTURES TO BE ADJUSTED	EACH	9	9		
Z0017500	DRAINAGE & UTILITY STRUCTURE ADJUSTMENT (SPECIAL)	EACH	18	18		
Z0017700	DRAINAGE & UTILITY STRUCTURES TO BE RECONSTRUCTED	EACH	2	2		
Z0030850	TEMPORARY INFORMATION SIGNING	SQ FT	104	104		
Z0076600	TRAINEES	HOUR	500		500	
Z0076604	TRAINEES TRAINING PROGRAM GRADUATE	HOUR	500		500	
	X4400503 X6020710 X6023508 X8860105 XX002260 XX003435 XX006429 XX006947 Z0013798 Z0017400 Z0017500 Z0017700 Z0030850 Z0076600	X4400501 COMBINATION CONCRETE CURB AND GUTTER REMOVAL AND REPLACEMENT LESS THAN OR EQUAL TO 10 FEET X4400503 COMBINATION CONCRETE CURB AND GUTTER REMOVAL AND REPLACEMENT GREATER THAN 10 FEET X6020710 CATCH BASINS TO BE ADJUSTED WITH SPECIAL FRAME AND GRATE X6023508 INLETS, TYPE A, WITH SPECIAL FRAME AND GRATE X8860105 DETECTOR LOOP REPLACEMENT XX002260 STRUCTURES TO BE REMOVED XX003435 PORTLAND CEMENT CONCRETE DRIVEWAY REMOVAL AND REPLACEMENT XX006429 SIDEWALK, SPECIAL XX006947 HOT-MIX ASPHALT DRIVEWAY REMOVAL AND REPLACEMENT Z0013798 CONSTRUCTION LAYOUT Z0017400 DRAINAGE & UTILITY STRUCTURES TO BE ADJUSTED Z0017500 DRAINAGE & UTILITY STRUCTURE ADJUSTMENT (SPECIAL) Z0017700 DRAINAGE & UTILITY STRUCTURES TO BE RECONSTRUCTED Z0030850 TEMPORARY INFORMATION SIGNING	X4400501 COMBINATION CONCRETE CURB AND GUTTER REMOVAL AND REPLACEMENT LESS THAN OR EQUAL TO 10 FEET X4400503 COMBINATION CONCRETE CURB AND GUTTER REMOVAL AND REPLACEMENT GREATER THAN 10 FEET X6020710 CATCH BASINS TO BE ADJUSTED WITH SPECIAL FRAME AND GRATE EACH X6023508 INLETS, TYPE A, WITH SPECIAL FRAME AND GRATE EACH X8860105 DETECTOR LOOP REPLACEMENT FOOT XX002260 STRUCTURES TO BE REMOVED EACH XX003435 PORTLAND CEMENT CONCRETE DRIVEWAY REMOVAL AND REPLACEMENT SQ YD XX006429 SIDEWALK, SPECIAL SQ FT XX006947 HOT-MIX ASPHALT DRIVEWAY REMOVAL AND REPLACEMENT SQ YD Z0013798 CONSTRUCTION LAYOUT L SUM Z0017500 DRAINAGE & UTILITY STRUCTURES TO BE ADJUSTED EACH Z0017700 DRAINAGE & UTILITY STRUCTURE ADJUSTMENT (SPECIAL) EACH Z0017700 TRAINAGE & UTILITY STRUCTURES TO BE RECONSTRUCTED EACH Z00176600 TRAINEES HOUR	X4400501 COMBINATION CONCRETE CURB AND GUTTER REMOVAL AND REPLACEMENT LESS THAN OR EQUAL TO 10 FEET FOOT 215 X4400503 COMBINATION CONCRETE CURB AND GUTTER REMOVAL AND REPLACEMENT GREATER THAN 10 FEET FOOT 980 X6020710 CATCH BASINS TO BE ADJUSTED WITH SPECIAL FRAME AND GRATE EACH 66 X6023508 INLETS, TYPE A, WITH SPECIAL FRAME AND GRATE EACH 1 X8060105 DETECTOR LOOP REPLACEMENT FOOT 1,185 XX002260 STRUCTURES TO BE REMOVED EACH 1 XX003435 PORTLAND CEMENT CONCRETE DRIVEWAY REMOVAL AND REPLACEMENT SQ YD 565 XX006429 SIDEWALK, SPECIAL SQ FT 500 XX006947 HOT-MIX ASPHALT DRIVEWAY REMOVAL AND REPLACEMENT SQ YD 250 Z0013798 CONSTRUCTION LAYOUT L SUM 1 Z0017600 DRAINAGE & UTILITY STRUCTURES TO BE ADJUSTED EACH 9 Z0017500 DRAINAGE & UTILITY STRUCTURES TO BE RECONSTRUCTED EACH 2 Z0030850 TEMPORARY INFORMATION SIGNING SQ FT 104 Z0076600 TRAINEES HOUR	X4400501 COMBINATION CONCRETE CURB AND GUTTER REMOVAL AND REPLACEMENT LESS THAN OR EQUAL TO 10 FEET FOOT 215 215 X4400503 COMBINATION CONCRETE CURB AND GUTTER REMOVAL AND REPLACEMENT GREATER THAN 10 FEET FOOT 980 980 X6020710 CATCH BASINS TO BE ADJUSTED WITH SPECIAL FRAME AND GRATE EACH 66 66 X6023508 INLETS, TYPE A, WITH SPECIAL FRAME AND GRATE EACH 1 1 X660105 DETECTOR LOOP REPLACEMENT FOOT 1,185 1185 XX002280 STRUCTURES TO BE REMOVED EACH 1 1 XX003433 PORTLAND CEMENT CONCRETE DRIVEWAY REMOVAL AND REPLACEMENT SQ YD 565 585 XX006428 SIDEWALK, SPECIAL SQ FT 500 500 XX006947 HOT-MIX ASPHALT DRIVEWAY REMOVAL AND REPLACEMENT SQ YD 250 250 Z0013798 CONSTRUCTION LAYOUT L SUM 1 1 Z0017500 DRAINAGE & UTILITY STRUCTURES TO BE ADJUSTED EACH 9 9 Z0017500 DRAINAGE & UTILITY STRUCTURE ADJUSTMENT (SPECIAL) EACH 18 <t< td=""><td> X4400501 COMBINATION CONCRETE CURB AND GUTTER REMOVAL AND REPLACEMENT FOOT 215 215 </td></t<>	X4400501 COMBINATION CONCRETE CURB AND GUTTER REMOVAL AND REPLACEMENT FOOT 215 215

~ INDICATES SPECIALTY ITEM

FILE NAME =	USER AAMs : bisburne	DESIGNED -	BRL	REVISED -					F.A.U. RTE.	SECTION	COUNTY	TOTAL SHEET
NING, ENDALER EIGHTS N8400510289 NC IVIT NS00	D208-4.SnT	DRAWN -	BRL	REVISED -	STATE OF ILLINOIS		SUMMARY OF QUANTITIES		1379	21-00073-00-RS	DUPAGE	40 7
	PLOT SCALE = NOT TO SCALE	CHECKED	AMP	REVISED	DEPARTMENT OF TRANSPORTATION				13131	21-00073-00-103	CONTRACT	T NO. 61.185
	PLO CATE = 9/13/2823	DATE -	9/13/2023	REVISED -		SCALE: N.T.S.	SHEET NO. 7 OF 40 SHEETS STA.	TO STA.	1	ILLINOIS FED. A		

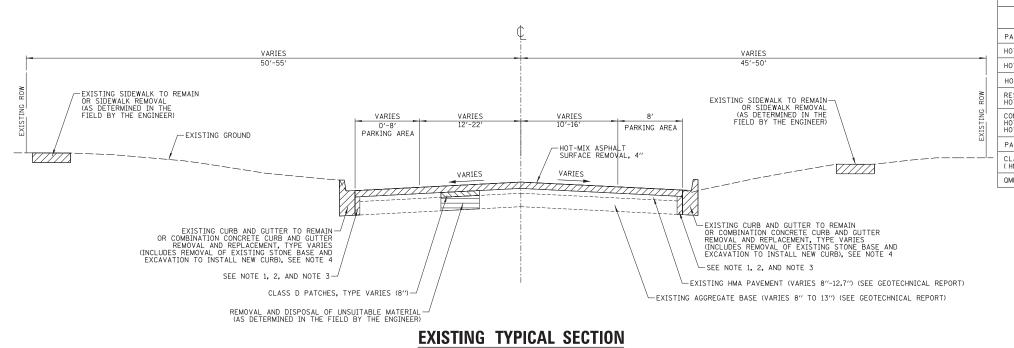

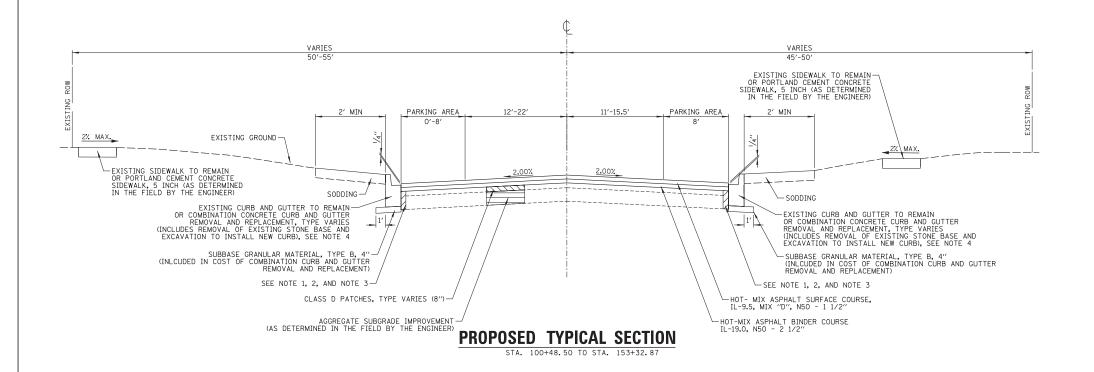

	HOT-MIX ASPHALT MIXTURE REQUIREM	MENTS	
	MIXTURE ITEM	AIR VOIDS @ Ndes	QMP DESIGNATION
	PAVEMENT RESURFACING		
	HOT-MIX ASPHALT SURFACE COURSE, IL-9.5, MIX "D", N50, 1 1/2"	4% @ 50 GYR	LR 1030-2
	HOT-MIX ASPHALT BINDER COURSE, IL-19.0, N50, 2 1/2"	4% @ 50 GYR	LR 1030-2
	HOT-MIX ASPHALT DRIVEWAY REMOVAL AND REPLACEMENT		
	RESIDENTIAL HOT-MIX ASPHALT SURFACE COURSE, IL-9.5, MIX "D", N50; 3" (IN 2 LIFTS)	4% © 50 GYR	LR 1030-2
	COMMERCIAL HOT-MIX ASPHALT SURFACE COURSE, IL-9.5, MIX "D", N50; 2" HOT-MIX ASPHALT BINDER COURSE, IL-19.0, N50, 4"	4% @ 50 GYR 4% @ 50 GYR	LR 1030-2 LR 1030-2
	PATCHING		
-	CLASS D PATCHES, TYPE (I,II,III,IV) 8 INCHES (HMA BINDER IL-19)	4% @ 70 GYR	LR 1030-2
	OMP DESIGNATION: OHALITY CONTROL/OHALITY ASSUARNCE (OA/OC) PER LR 1030-2		


- NOTES:

 1. THE UNIT WEIGHT USED TO CALCULATE ALL HMA SURFACE MIXTURE QUANTITIES IS 112 LBS/SQ YD/IN.
- 2. THE "AC TYPE" FOR POLYMERIZED HMA MIXES SHALL BE "SBS/SBR PG 76 -22" AND FOR NON-POLYMERIZED HMA THE "AC TYPE" SHALL BE "PG 64 -22" UNLESS MODIFIED BY RECLAIMED MATERIALS SPECIFICATIONS.

GENERAL NOTES:

- 1. PAVEMENT REMOVAL ADJACENT TO PROPOSED CURB AND GUTTER SHALL BE INCLUDED IN THE COST OF THE PROPOSED CURB AND GUTTER.
- 2. LIMITS OF CURB AND GUTTER REPAIR WORK TO BE MARKED IN FIELD BY ENGINEER PRIOR TO CONSTRUCTION.
- 3. ALL WORK INCLUDING SOD MUST BE COMPLETED AND APPROVED BY ENGINEER PRIOR TO FINAL PAYOUT.
- 4. FOR ROADWAYS WITH DIFFERING ELEVATIONS AT THE EDGE OF PAVEMENT, CONTRACTOR SHALL PAVE THE SIDE WITH THE HIGHER ELEVATION FIRST. THE CONTRACTOR SHALL PROVIDE GRADE STAKES SHOWING FINISHED PAVEMENT GRADES AT 2% (MIN) OFF HIGH SIDE OF CENTERLINE ELEVATION.
- 5. CONTRACTOR SHALL VERIFY CROSS SLOPE OF ROADWAY MEETS 2% (MIN).
 ANY AREAS THAT DO NOT MEET THIS REQUIREMENT SHALL BE CORRECTED
 BY THE CONTRACTOR PRIOR TO PAYMENT.
- 6. CONTRACTOR SHALL MILL THE EXISTING PAVEMENT PRIOR TO INSTALLATION OF PATCHING.

FILE NAME =	USER NAME = blibunao	DESIGNED - BRL	REVISED -		FULLERTON AVENUE RESURFACING	F.A.U.	SECTION	COUNTY TOTAL SHEET
N:\GLENDALEHEIGHTS\040051D208\C1v1\TYF	D208.SHT	DRAWN - BRL	REVISED -	STATE OF ILLINOIS	TYPICAL SECTIONS	1379	21-00073-00-RS	DUPAGE 40 8
	PLOT SCALE = NOT TO SCALE	CHECKED - AMP	REVISED -	DEPARTMENT OF TRANSPORTATION	TITIONE SESTIONS			CONTRACT NO. 61J85
	PLOT DATE = 9/1/2023	DATE - 9/1/2023	REVISED -		SCALE: N.T.S. SHEET NO. 8 OF 40 SHEETS STA. TO STA.		ILLINOIS FED. A	AID PROJECT

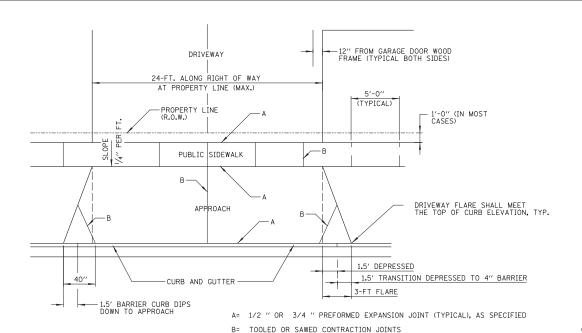


DRIVEWAY WITH CURB AND GUTTER

GENERAL NOTES:


FILE NAME =

- 1. DRIVEWAY SHALL NOT EXCEED 24 FT. IN WIDTH MEASURED AT THE RIGHT OF WAY
- 2. DRIVEWAY SHALL HAVE A MIN. SLOPE OF 2% AND MAX. SLOPE OF PREFERABLY 8%.
- 3. APPROACH SHALL HAVE A MIN, SLOPE OF 2% AND MAX. OF 10%
- 4. ALL AGGREGATE SUB-BASE SHALL BE MECHANICALLY COMPACTED, (95% PROCTOR)
- 5. PUBLIC SIDEWALK SHALL BE 6" THICK P.C. CONCRETE AT DRIVEWAY. (NO WIRE MESH) (PAID FOR AS P.C.C. SIDEWALK, 5 INCH)
- 6. MINIMUM THICKNESS FOR APPROACH, (NO WIRE MESH) INCLUDED IN COST FOR DRIVEWAY REPLACEMENT.
 A. 6" P.C. CONCRETE (HIGH EARLY STRENGTH) ON 4" COMPACTED AGGREGATE BASE COURSE, TYPE B BY P.C. CONCRETE (HIGH EARLY STRENGTH) ON 6" COMPACTED AGGREGATE BASE COURSE, TYPE B (COMMERCIAL DRIVEWAYS)
 - B. 3" HOT-MIX ASPHALT SURFACE ON 6" COMPACTED AGGREGATE BASE COURSE, TYPE B 2" HOT-MIX ASPHALT SURFACE AND 4" HOT-MIX ASPHALT BINDER ON 8" AGGREGATE BASE COURSE, TYPE B (COMMERCIAL DRIVEWAYS)

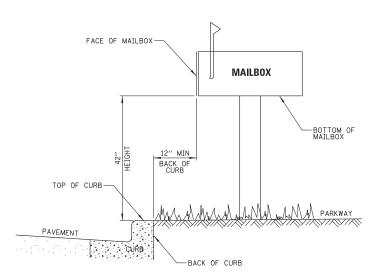

LOCATION OF MAILBOX IN PARKWAY AREAS

USER NAME = blibunao

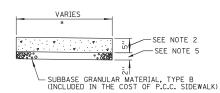


* CROSS SLOPE 0.5% (MIN.) TO 1.9% (MAX.) OR AS SHOWN ON ADA CURB RAMP DETAILS

NOTES:

- 1. ALL REQUIRED EARTH EXCAVATION TO CONSTRUCT P.C.C. SIDEWALK SHALL BE INCIDENTAL TO THE P.C.C. SIDEWALK 5 INCH. THIS INCLUDES SIDEWALK THAT MAY BE RELOCATED.
- THICKNESS SHALL BE INCREASED TO 6" WHERE SIDEWALK IS ADJACENT TO A DRIVEWAY AND 5" WHERE SIDEWALK IS LOCATED WITHIN DUPAGE COUNTY RIGHT-OF-WAY. NO WIRE MESH. (INCLUDED IN THE COST OF P.C.C SIDEWALK).
- SIDEWALN.

 3. IN LOCATIONS WHERE SIDEWALK IS REMOVED AND REPLACED THROUGH DRIVEWAYS, DRIVEWAYS SHALL BE SAWCUT AND PATCHED A MINIMUM OF 1' ON EITHER SIDE OF THE WALK. THIS WORK SHALL BE PAID FOR PER SQUARE YARD AT THE CONTRACT UNIT PRICE FOR CONCRETE DRIVEWAY REPLACEMENT OR HOT-MIX ASPHALT DRIVEWAY REPLACEMENT.
- 5. SIDEWALKS SHALL BE PLACED ON 2" OF SUBBASE GRANULAR MATERIAL WHEN REPLACING EXISTING SIDEWALK, AND 4" OF SUBBASE GRANULAR MATERIAL WHEN CONSTRUCTING NEW SIDEWALK, (INCLUDED IN THE COST OF SIDEWALK)

PORTLAND CEMENT CONCRETE SIDEWALK 5 INCH DETAIL

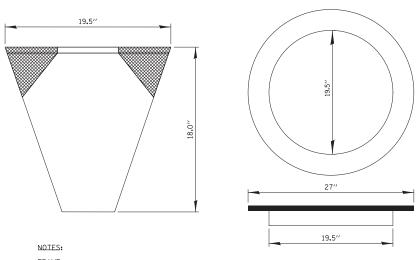

FRAME SHALL BE FABRICATED FROM V_8'' FLAT STACK. BASE RING SHALL BE FABRICATED FROM $1/2'' \times 1/2'' \times V_8''$ CHANNEL, DOMESTIC STEEL CONFORMING TO ASTM-AST

SEDIMENT BAG: SHALL BE FABRICATED FROM 4 OZ/SO YD NON-WAVEN POLYPROPYLENE GEOTEXTILE AND SHALL BE REINFORCED WITH POLYESTER MESH. THE BAG SHALL BE SECURED TO THE BASE RING WITH STAINLESS STEEL STRAP AND LOCK.

CATCH BASIN AND INLET FILTER

N:\GLENDALEHEIGHTS\Ø4ØØ51D2Ø8\C1v1\DET1_D2Ø8,SHT DRAWN KK REVISED CHECKED REVISED DATE 9/1/2023 REVISED


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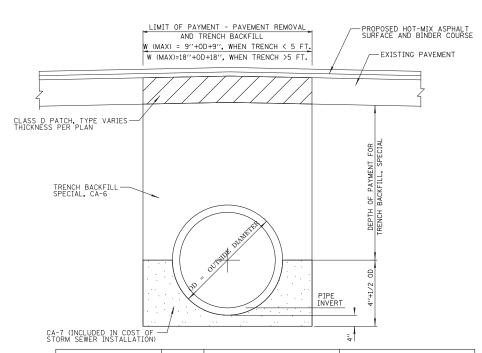
DESIGNED -

1 07/18/23

STATE OF ILLINOIS **DEPARTMENT OF TRANSPORTATION**

SCALE: N.T.S.




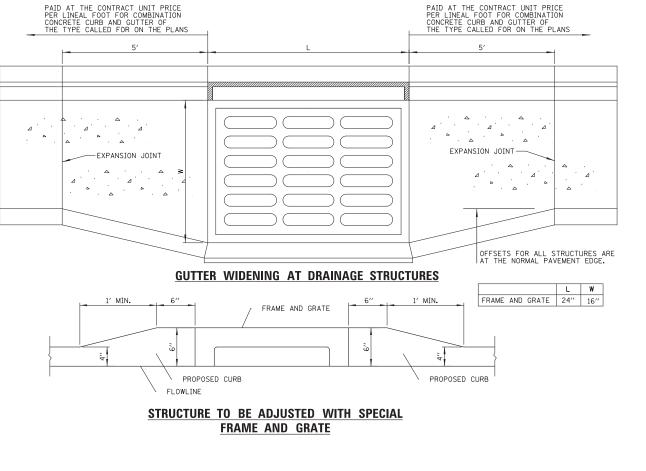

NOMINAL PIPE DIAMETER	PIPE OD	W (TRENCH WIDTH PAY LIMITS)	W (TRENCH WIDTH PAY LIMITS)
INCHES	INCHES	INCHES < 5' DEPTH	INCHES > 5' DEPTH
12"	16"	34''	52"
15"	19.5"	37.5"	55. 5"
18"	23"	41"	59"

TRENCH DETAIL FOR STORM SEWER


TOTAL SHEET NO. 40 9 COUNTY **FULLERTON AVENUE RESURFACING** 21-00073-00-RS DUPAGE CONSTRUCTION DETAILS CONTRACT NO. 61J85 SHEET NO. 9 OF 40 SHEETS STA. TO STA.

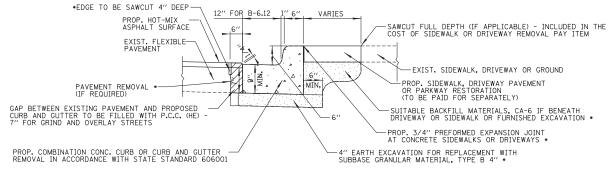

* INCLUDED IN THE COST FOR COMBINATION CONCRETE CURB AND GUTTER, TYPE B-6.12

- NOTES:
 1. LONGITUDINAL BARS, IF ENCOUNTERED IN THE EXISTING CURB OR CURB AND GUTTER, ARE NOT TO BE REPLACED. CUTTING AND REMOVING LONGITUDINAL BARS SHALL BE INCLUDED IN THE COST OF COMBINATION CURB GUTTER REMOVAL.
- 2. WORK TO INSTALL CURB AND GUTTER INCLUDES ALL NECESSARY PAVEMENT REMOVAL, EXCAVATION, EMBANKMENT AND SUBBASE GRANULAR MATERIAL. EXCAVATED MATERIAL WILL NOT BE PERMITTED TO BE STOCKPILED BEHIND THE CURB.
- 3. FOR GRIND AND OVERLAY STREETS, ANY EXISTING PAVEMENT REMOVAL ADJACENT TO THE NEW CURB AND GUTTER SHALL BE REPLACED WITH CLASS SI CONCRETE.
- 4. EXPANSION JOINTS PLACED AT A MAXIMUM 60 FEET SPACING. CONTRACTION JOINTS PLACED AT A MAXIMUM 20 FEET SPACING.
- 5. ALL FRAMING SHALL BE SET TO FINAL GRADE OF THE POUR. NO ANGLE IRONS WILL BE ALLOWED. NO WATERING CANS SHALL BE ALLOWED ON SITE.

COMBINATION CONCRETE CURB AND GUTTER, TYPE B-6.12

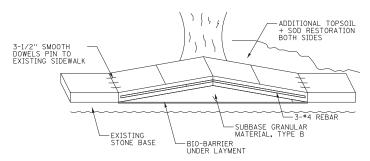

SIDEWALK SPECIAL (ROOT PRESERVATION)

FILE NAME =	USER NAME = blibunao	DESIGNED -	BRL	REVISED	-	1	07/18/23	Ι
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	PLOT DATE = 9/1/2023	DATE -	9/1/2023	REVISED	-			1

STATE OF ILLINOIS **DEPARTMENT OF TRANSPORTATION**

FULLERTON AVENUE RESURFACING		F.A.U. RTE.	SECTION	COUNTY	TOTAL SHEETS	SHEET NO.
CONSTRUCTION DETAILS		1379	21-00073-00-RS	DUPAGE	40	10
				CONTRAC [*]	T NO. F	61J85
CUEET NO 10 OF 10 CUEETC CTA	TO CTA					

AND GUTTER REMOVAL AND REPLACEMENT.	EDGE TO BE SAWCUT PROP. HOT-MIX ASPHALT SURFACE EXIST. FLEXIBLE PAVEMENT (IF REQUIRED) CAP BETWEEN EXISTING PAVEMENT AND PROPOSED— CURB AND GUTTER TO BE FILLED WITH STONE FOR VARIABLE FULL DEPTH STREETS * PCC (HE) - 7" FOR GRIND AND OVERLAY STREETS* PROP. COMBINATION CONC. CURB OR CURB AND REMOVAL AND REPLACEMENT IN ACCORDANCE WITH STATE STANDARD 606001	4" EARTH EXCAVATION AND REPLACEMENT WITH SUBBASE GRANULAR MATERIAL, TYPE B 4" * • INCLUDED IN THE COST FOR COMBINATION CONCRETE CURB
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SCALE: N.T.S.

NOTES:
1. LONGITUDINAL BARS, IF ENCOUNTERED IN THE EXISTING CURB OR CURB AND GUTTER, ARE NOT TO BE REPLACED. CUTTING AND REMOVING LONGITUDINAL BARS SHALL BE INCLUDED IN THE COST OF CURB OR CURB AND GUTTER REMOVAL AND REPLACEMENT (SPECIAL).


2. WORK TO REMOVE AND REPLACE CURB AND GUTTER INCLUDES ALL NECESSARY PAVEMENT REMOVAL, EXCAVATION, EMBANKMENT AND SUBBASE GRANULAR MATERIAL, EXCAVATED MATERIAL WILL NOT BE PERMITTED TO BE STOCKPILED BEHIND THE CURB.


3. FOR GRIND AND OVERLAY STREETS, ANY EXISTING PAVEMENT REMOVAL ADJACENT TO THE NEW CURB AND GUTTER SHALL BE REPLACED WITH CLASS SI CONCRETE, FOR STREETS WITH FULL DEPTH REPLACEMENT, ANY EXISTING PAVEMENT REMOVED ADJACENT TO THE NEW CURB AND GUTTER SHALL BE REPLACED WITH SUITABLE STONE BACKFILL.


4. EXPANSION JOINTS PLACED AT A MAXIMUM 60 FEET SPACING. CONTRACTION JOINTS PLACED AT A MAXIMUM 20 FEET SPACING.


5. ALL FRAMING SHALL BE SET TO FINAL GRADE OF THE POUR. NO ANGLE IRONS WILL BE ALLOWED, NO WATERING CANS SHALL BE ALLOWED ON SITE.


COMBINATION CONCRETE CURB AND GUTTER REMOVAL AND REPLACEMENT

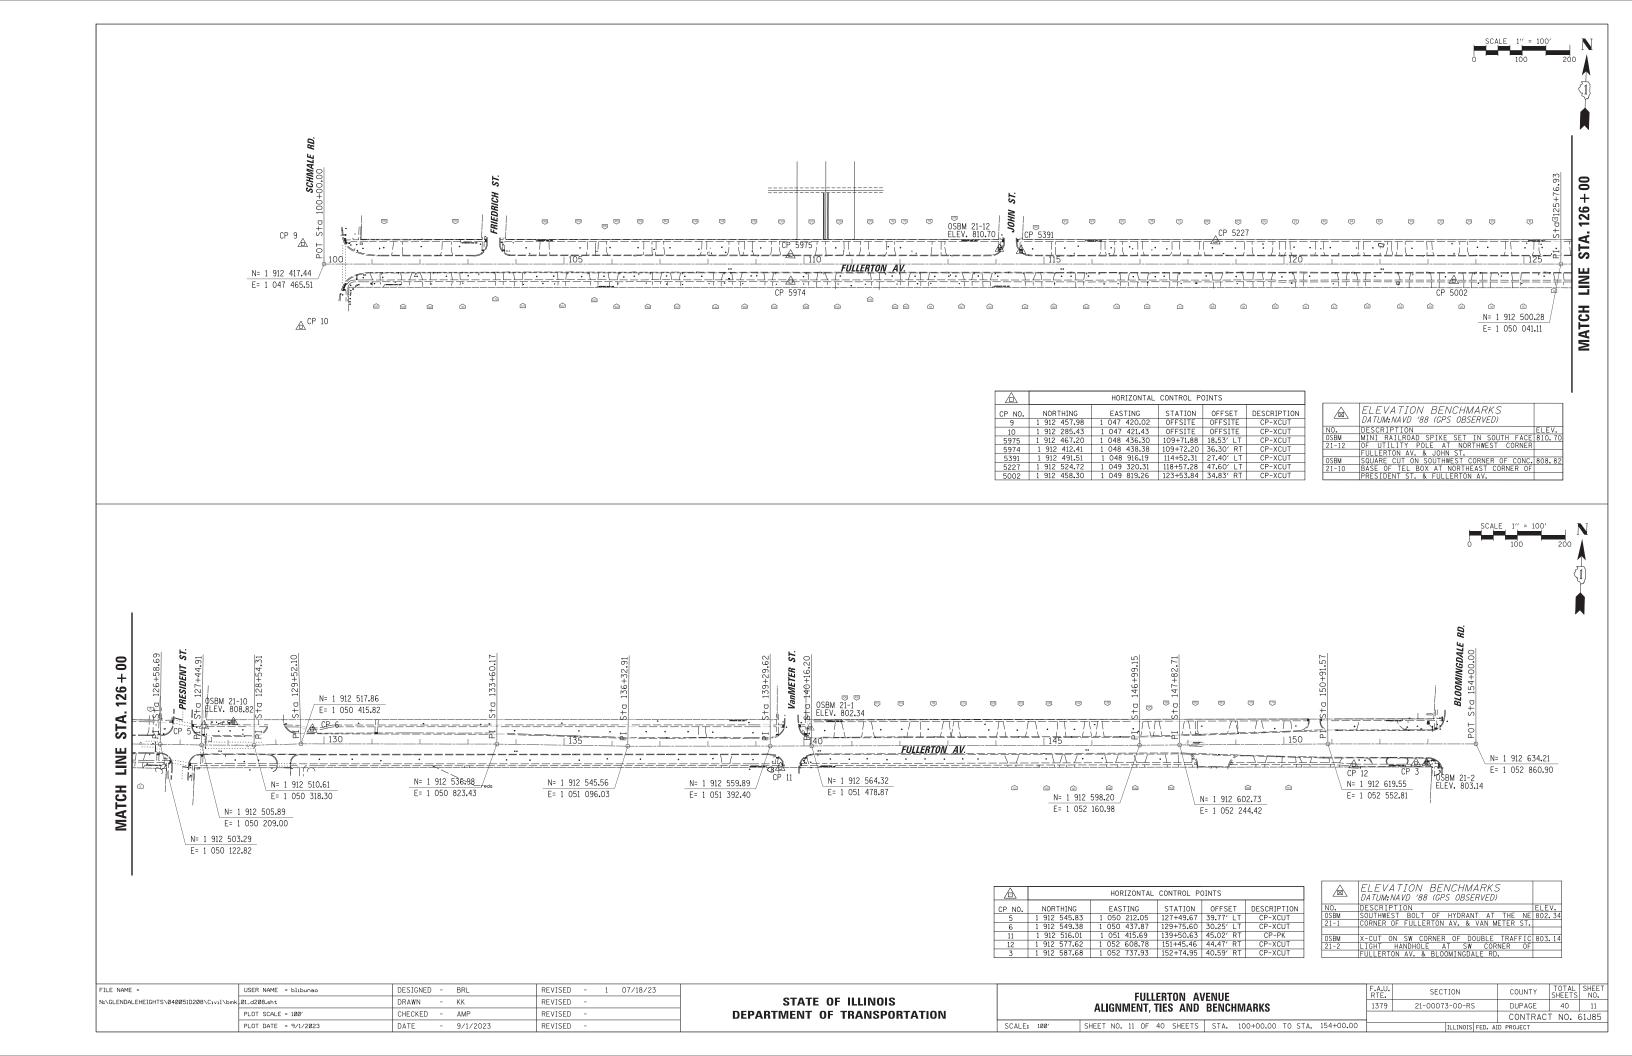


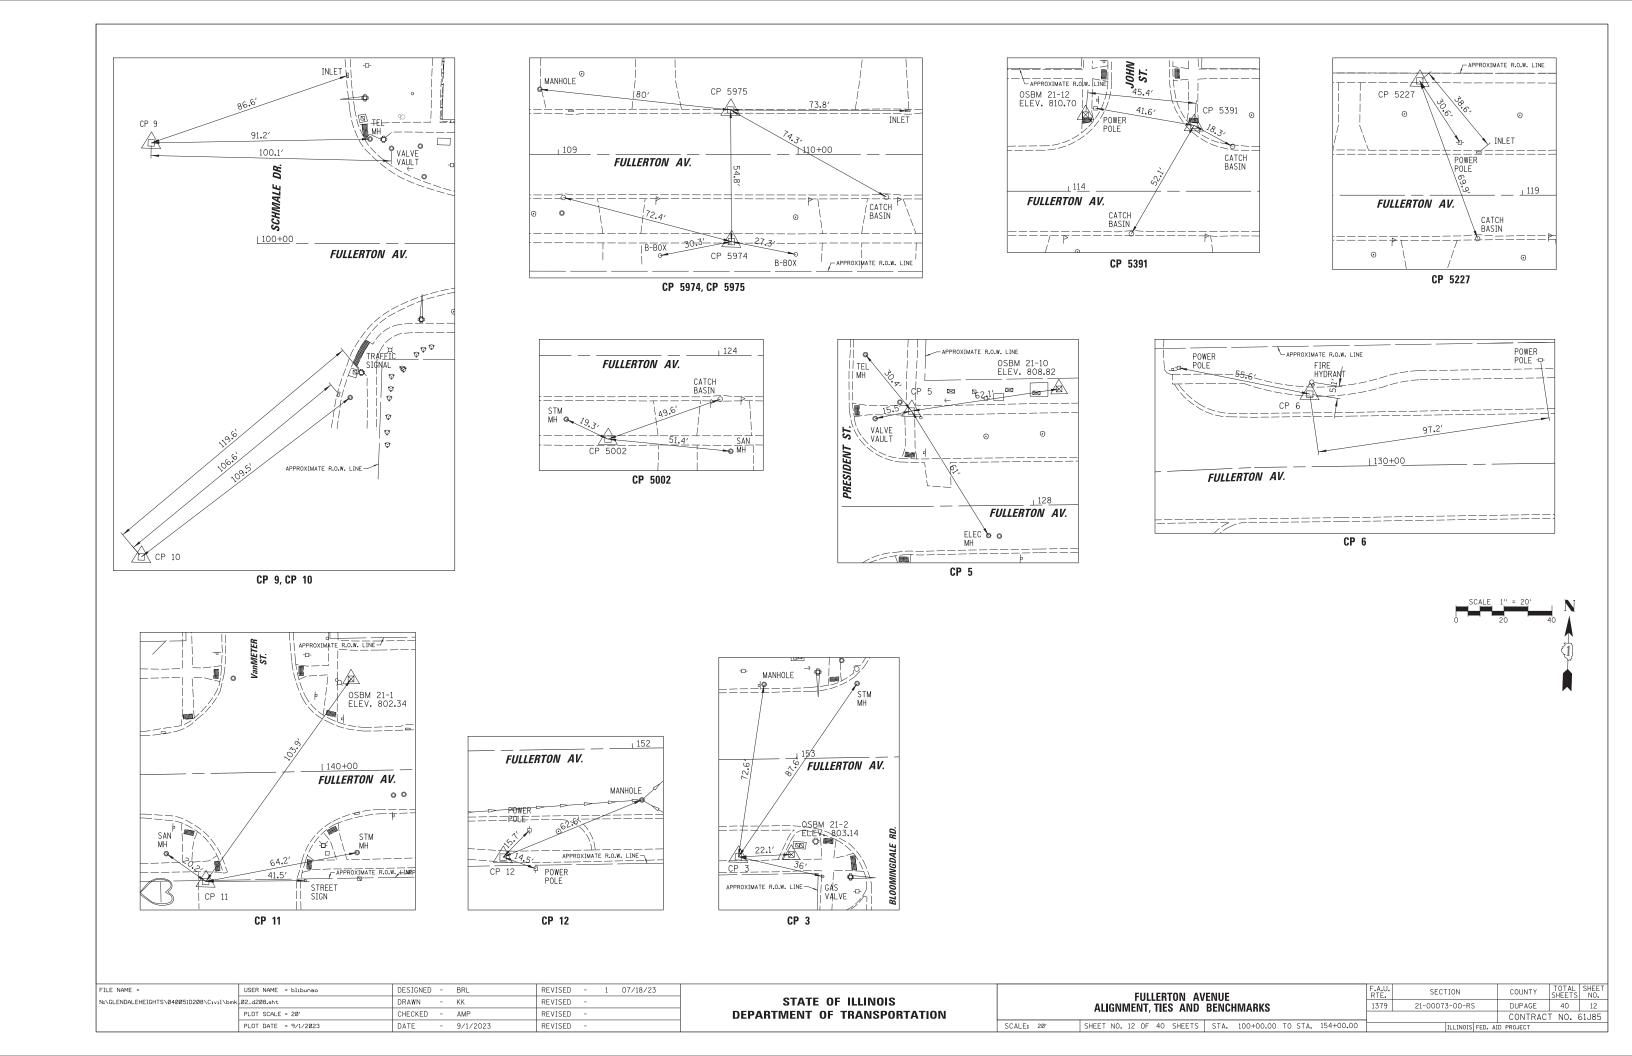


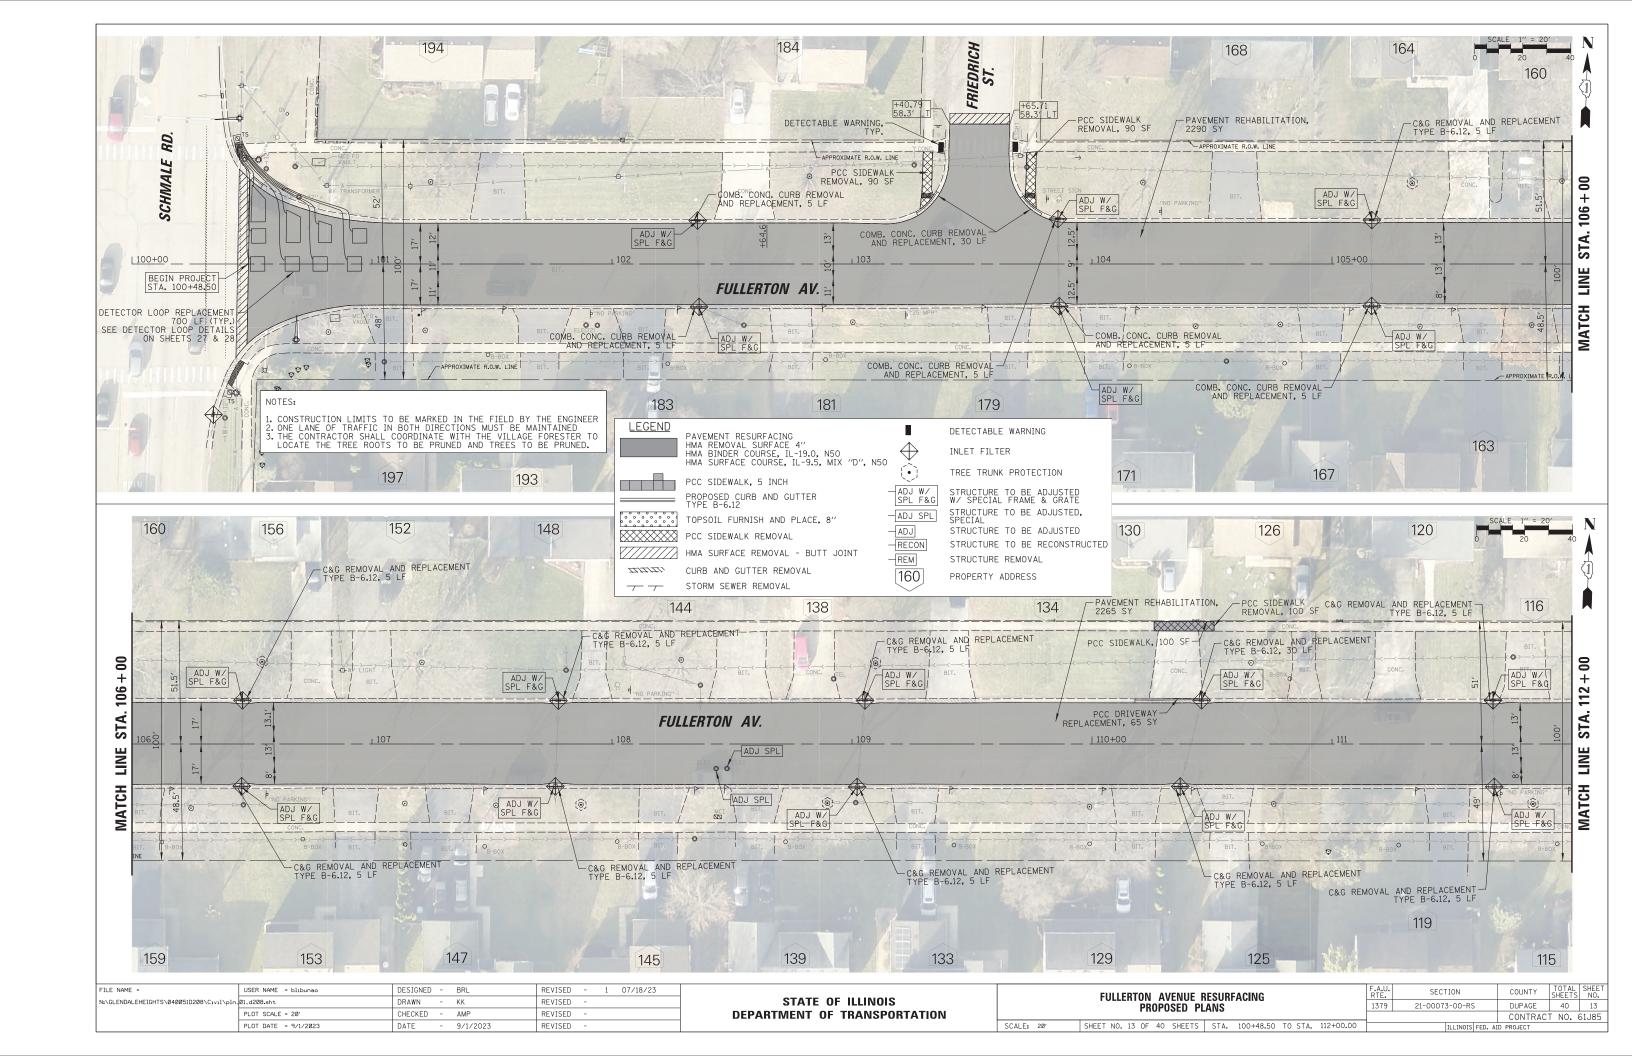


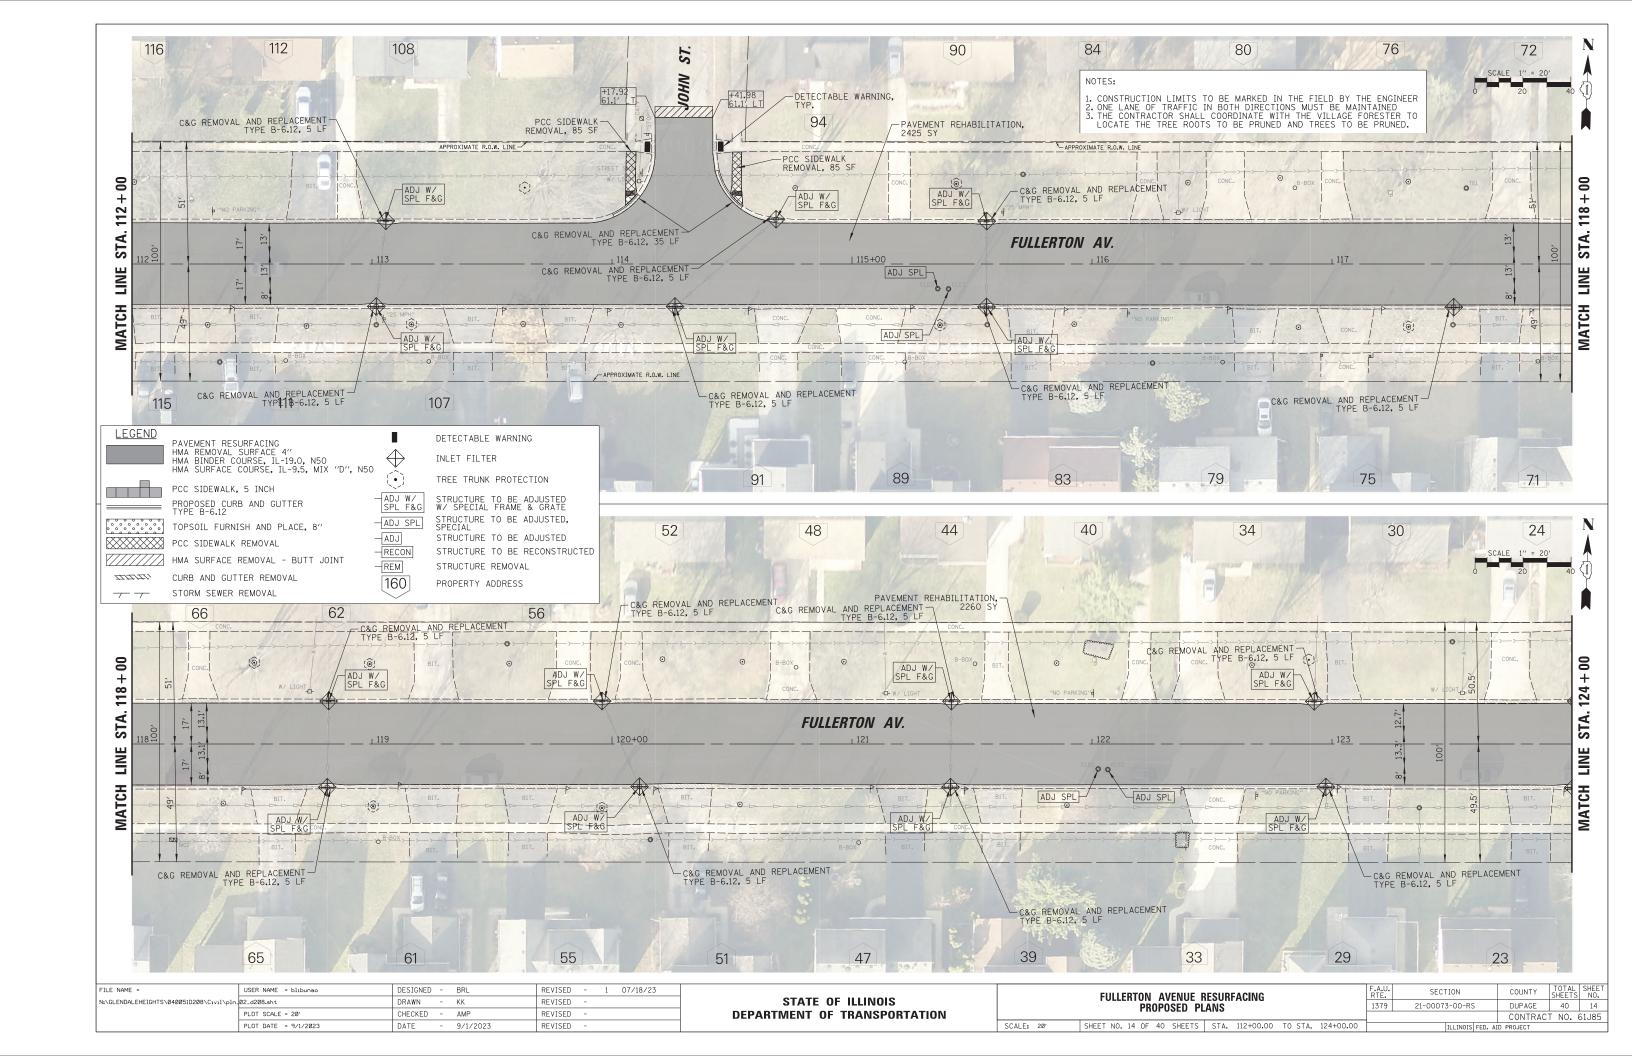


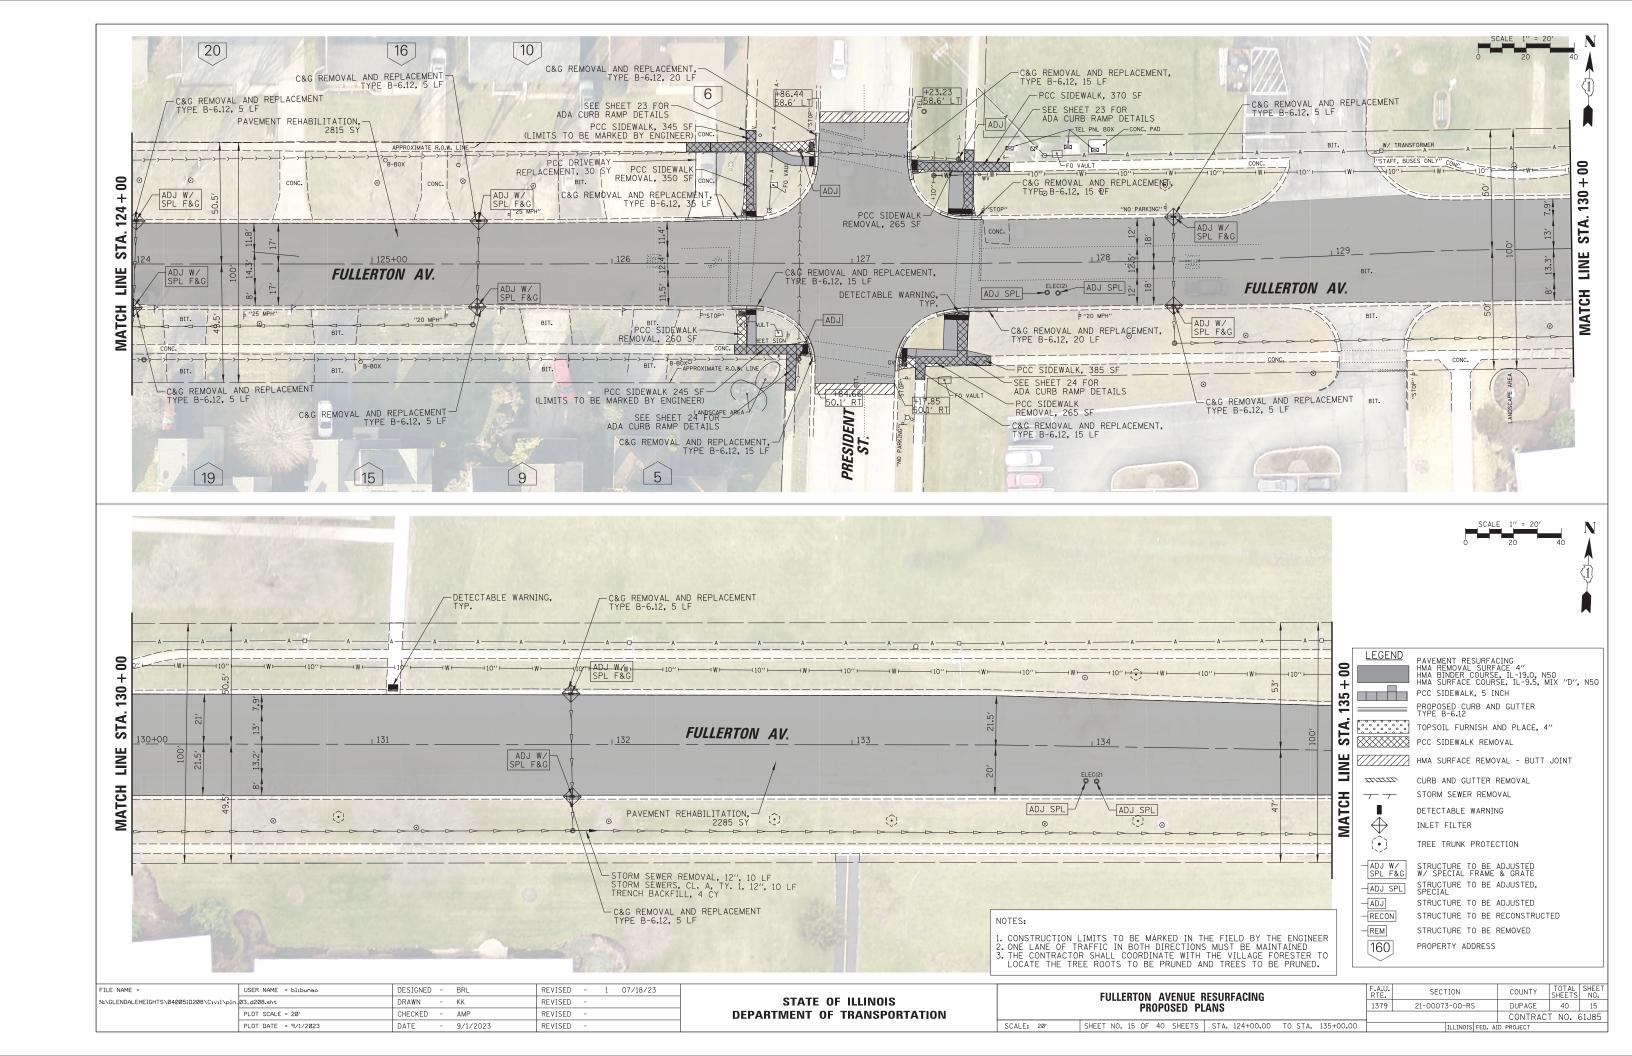


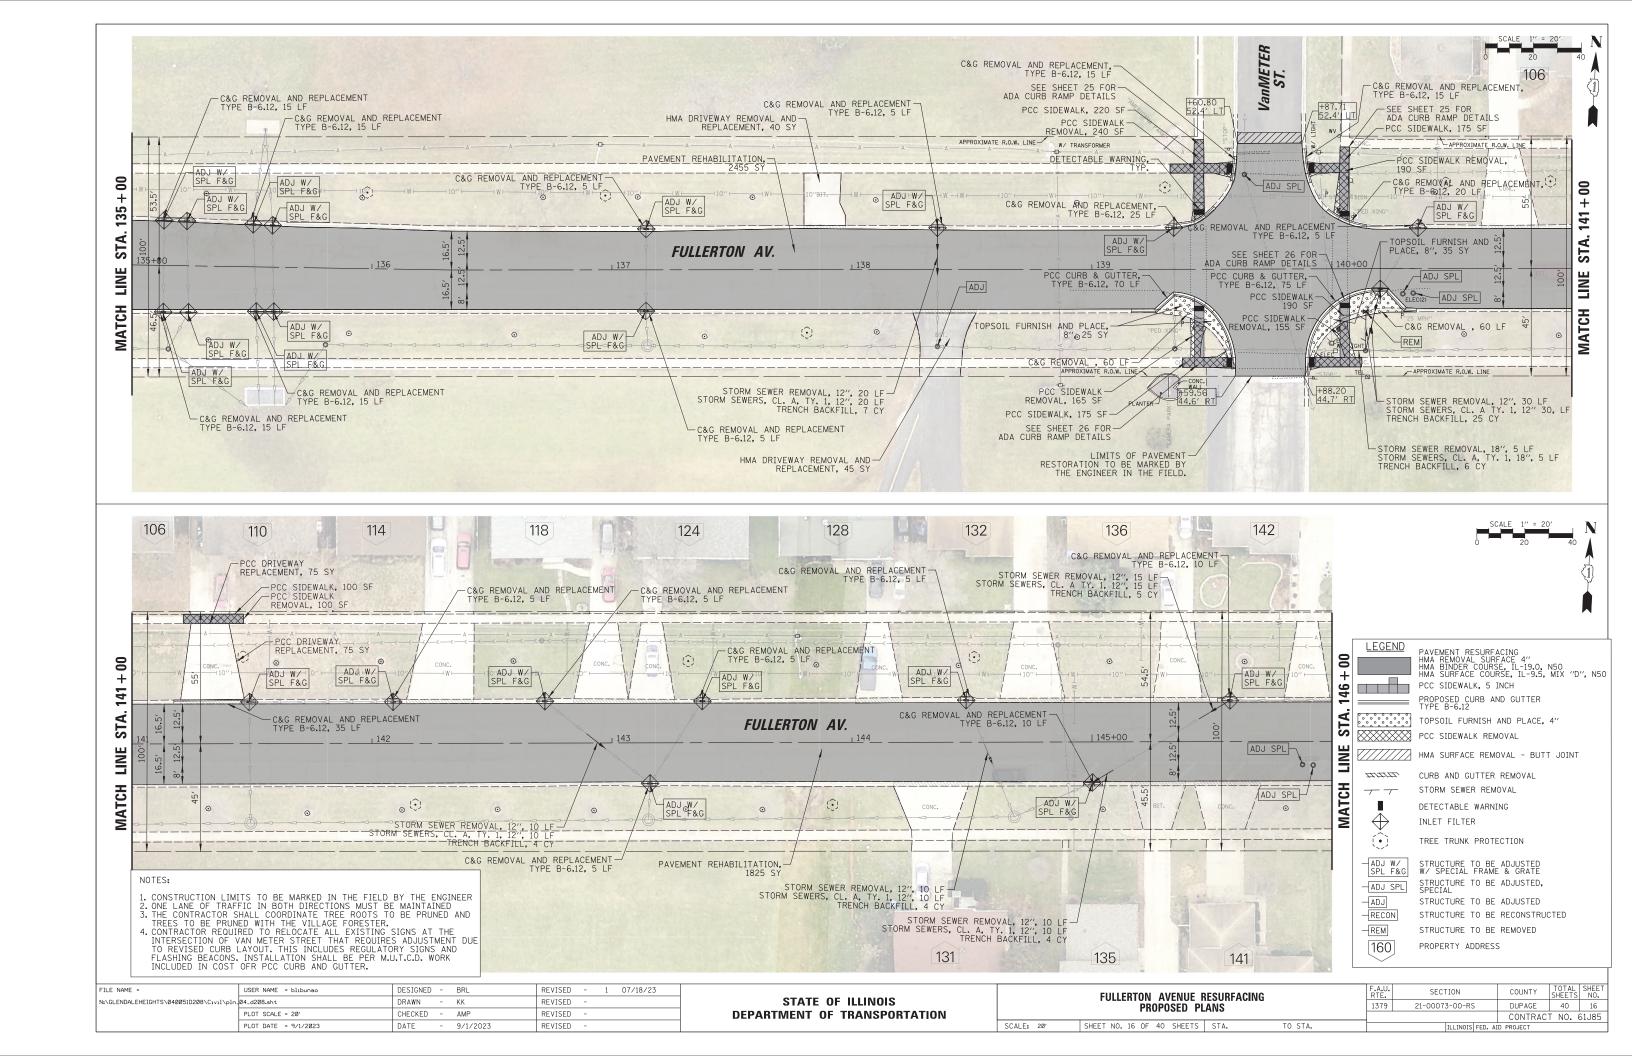


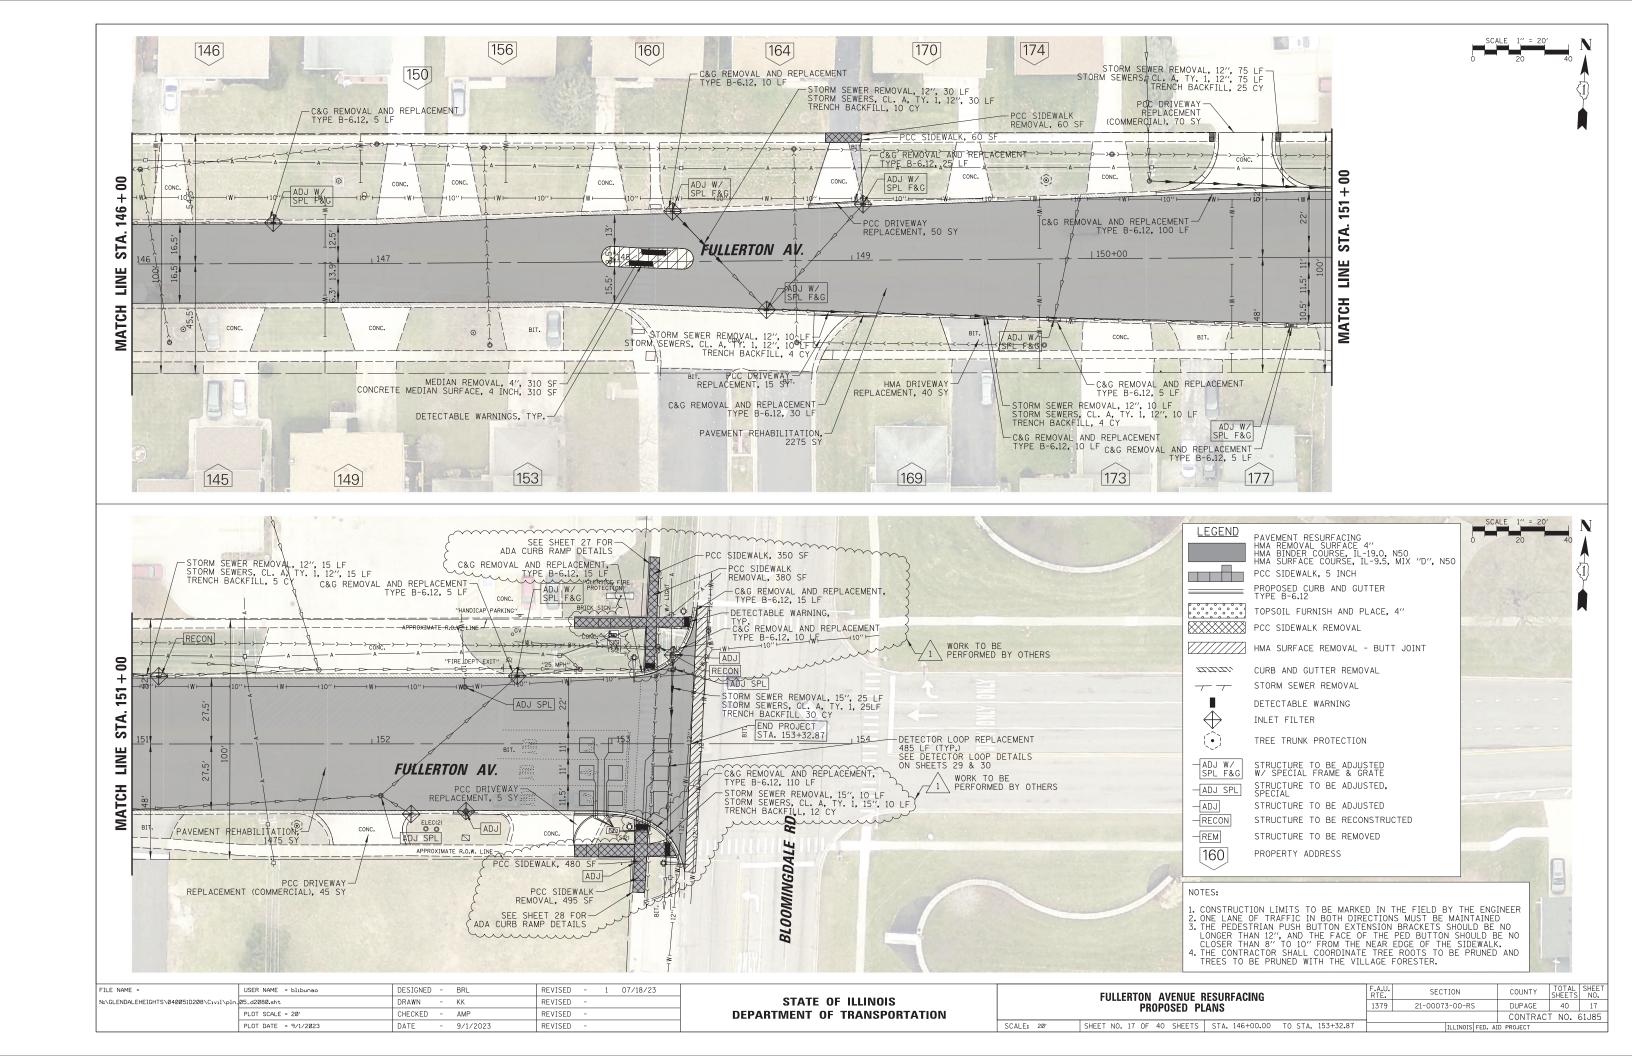


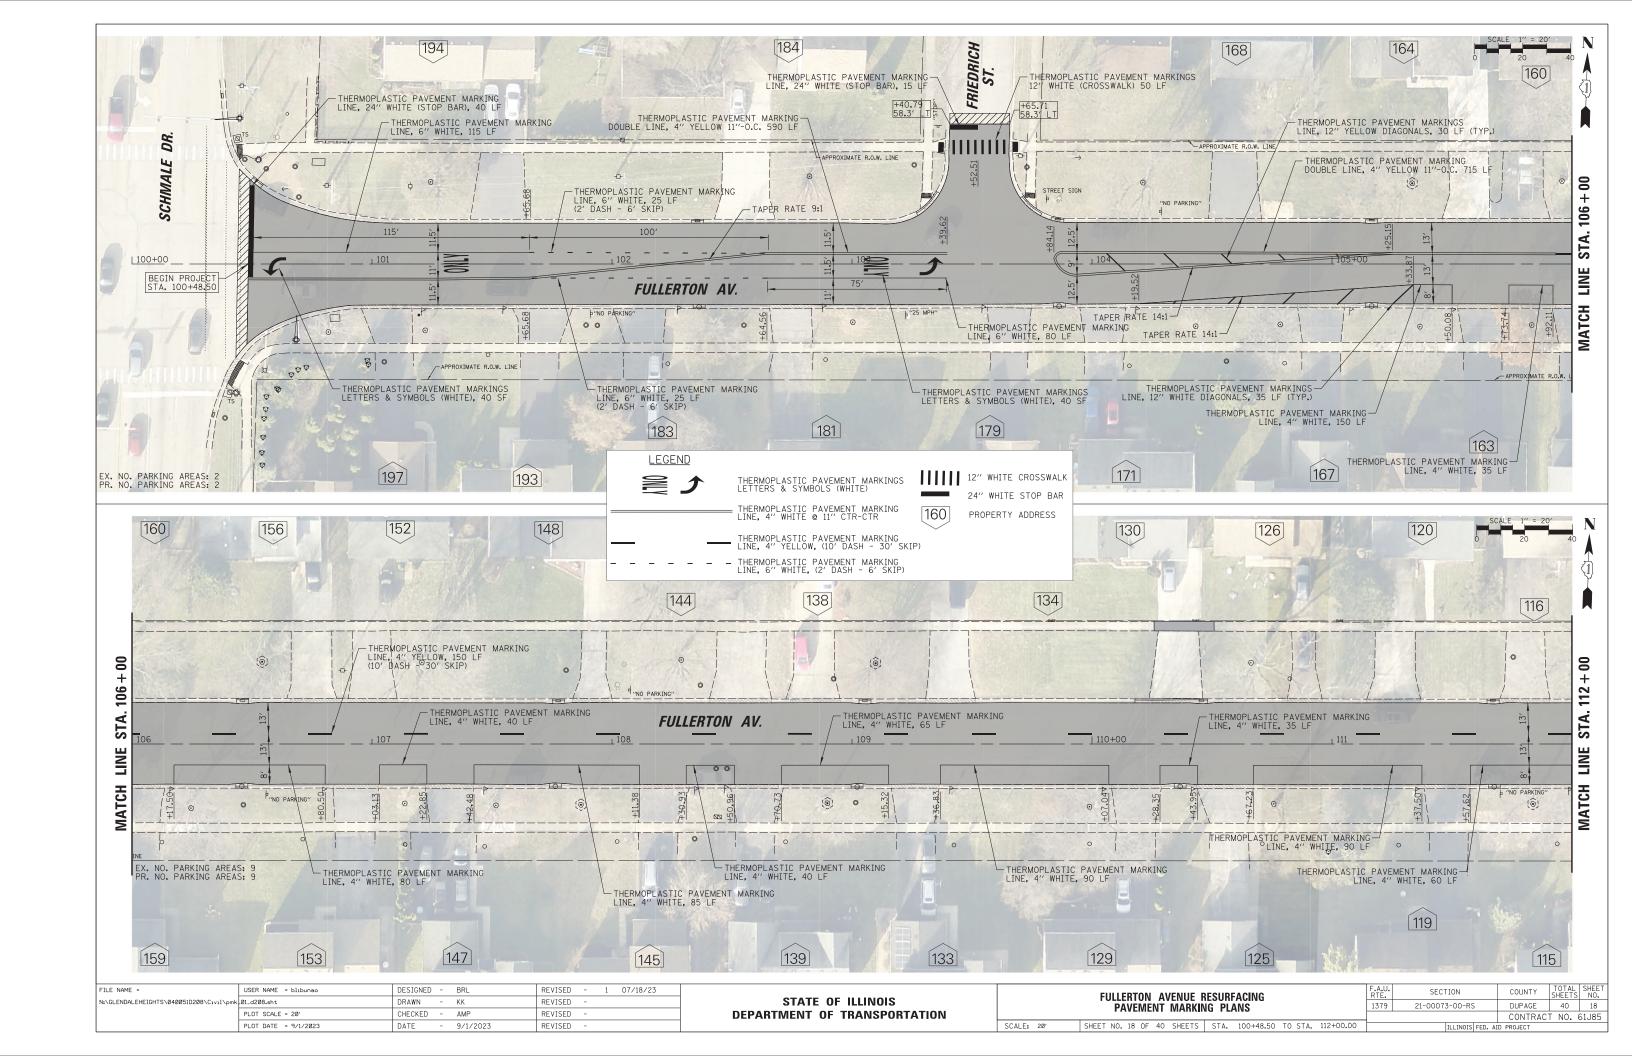


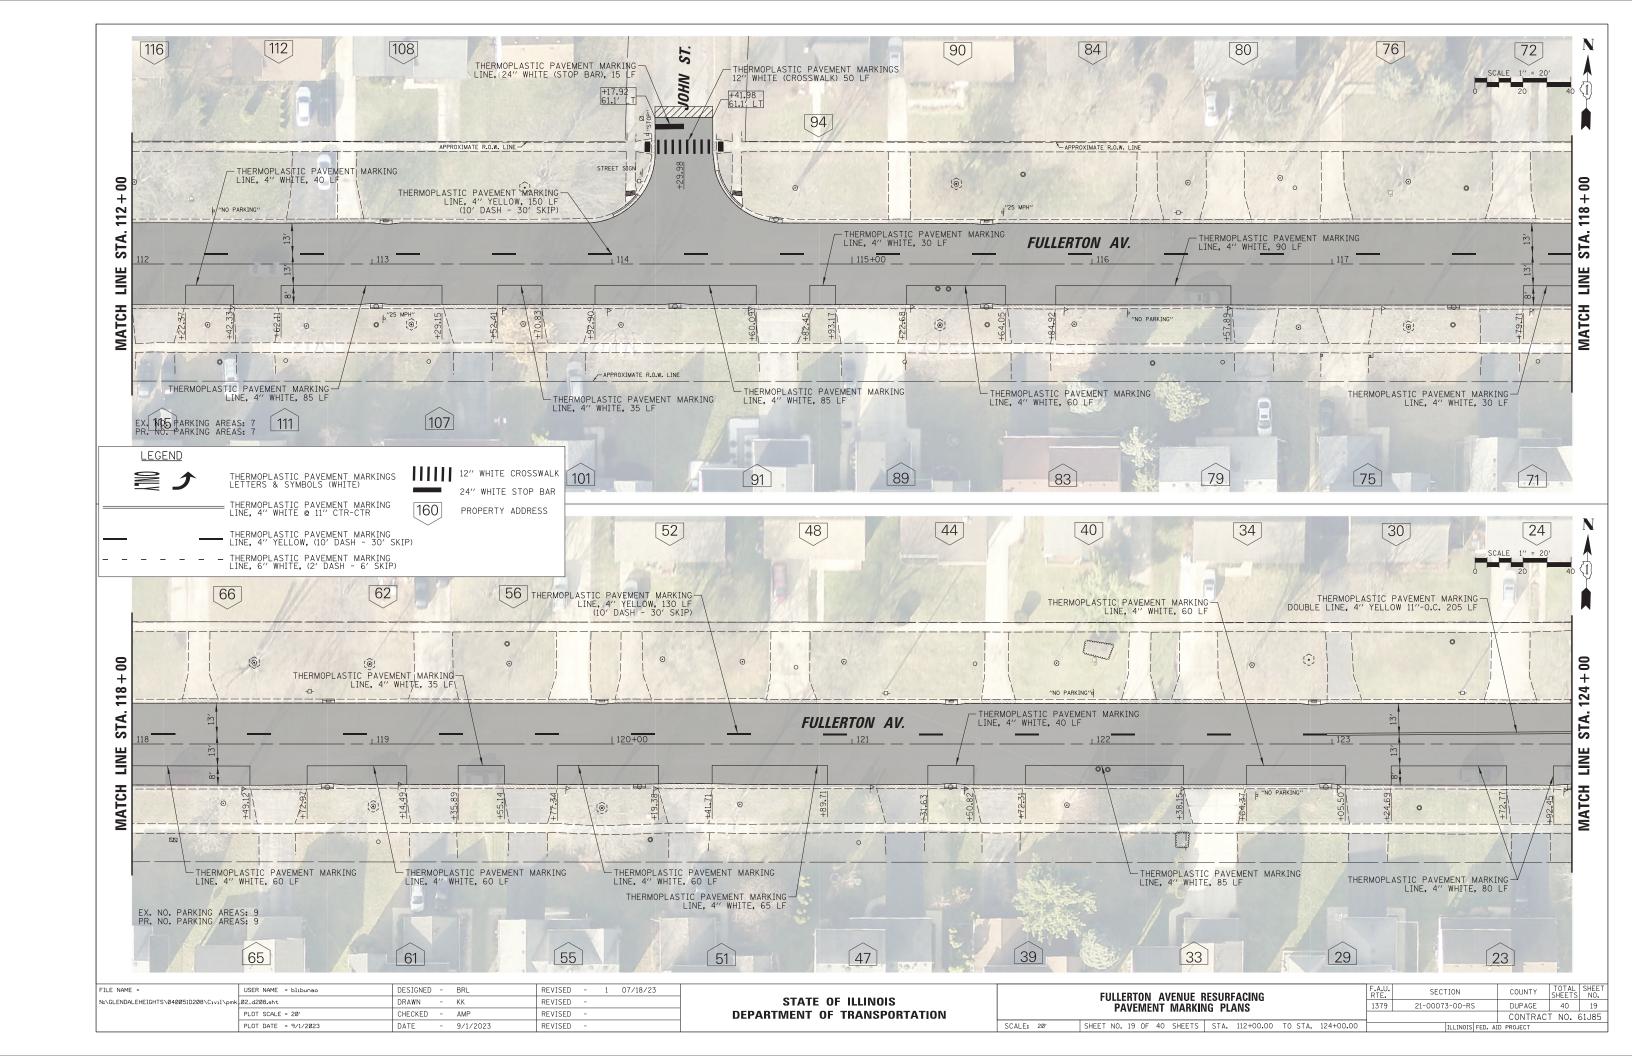


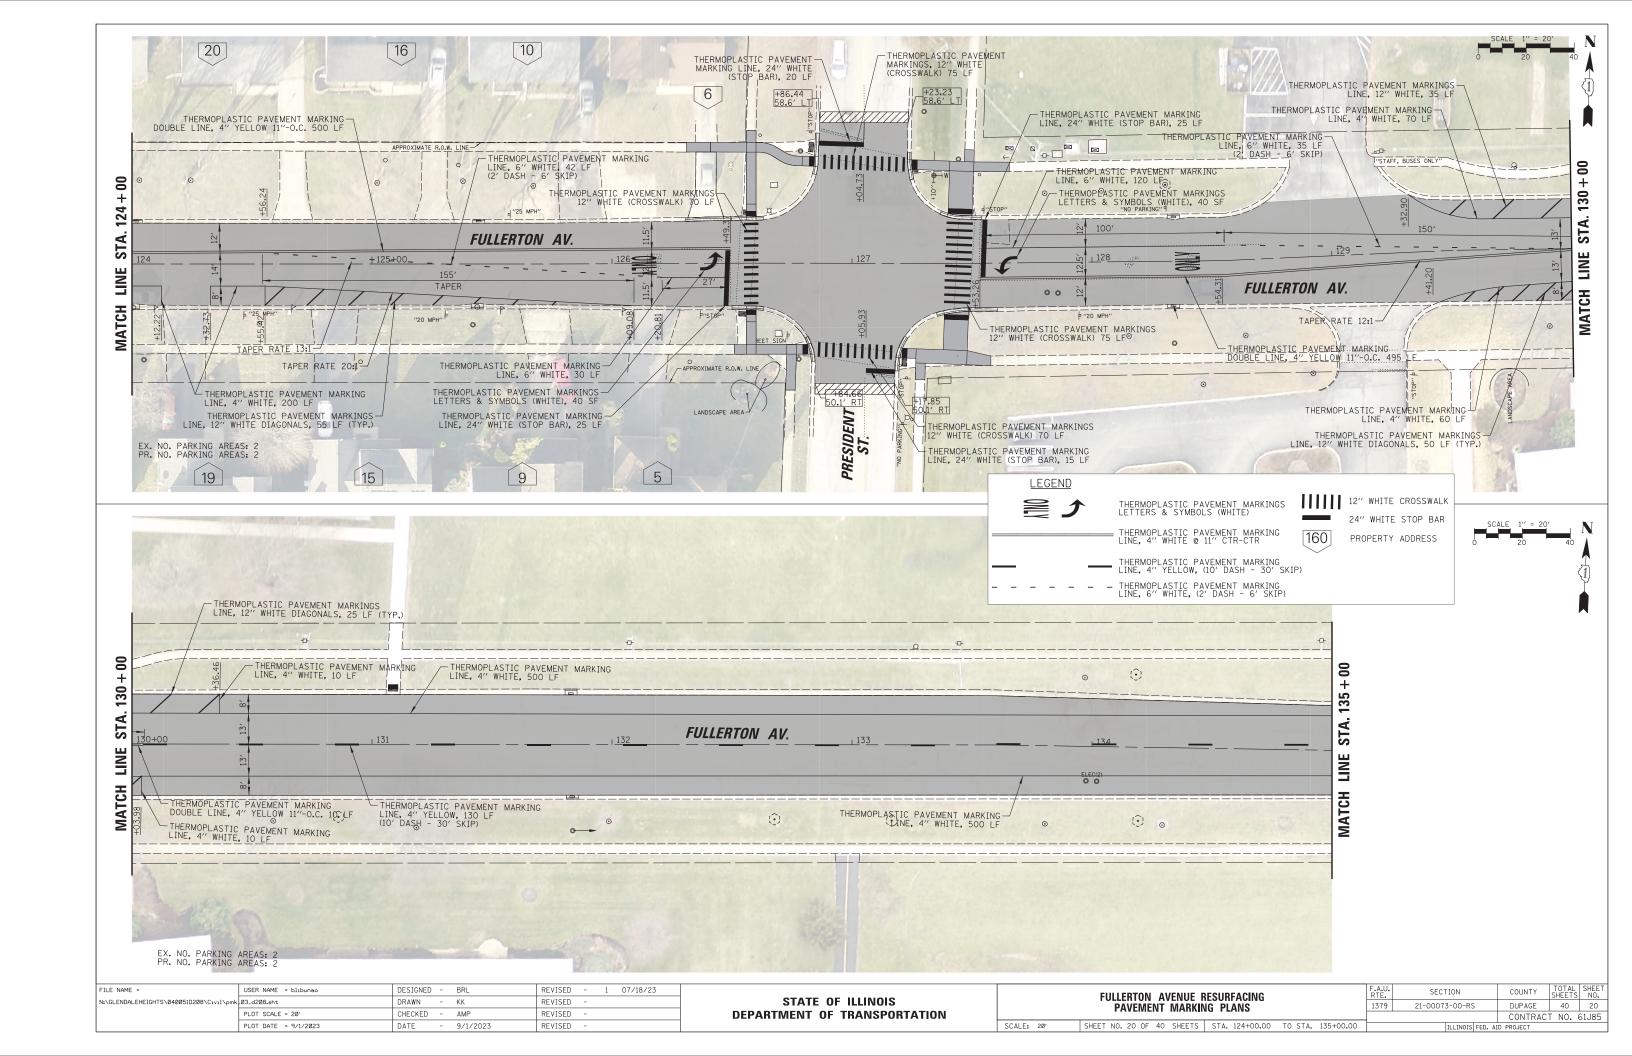


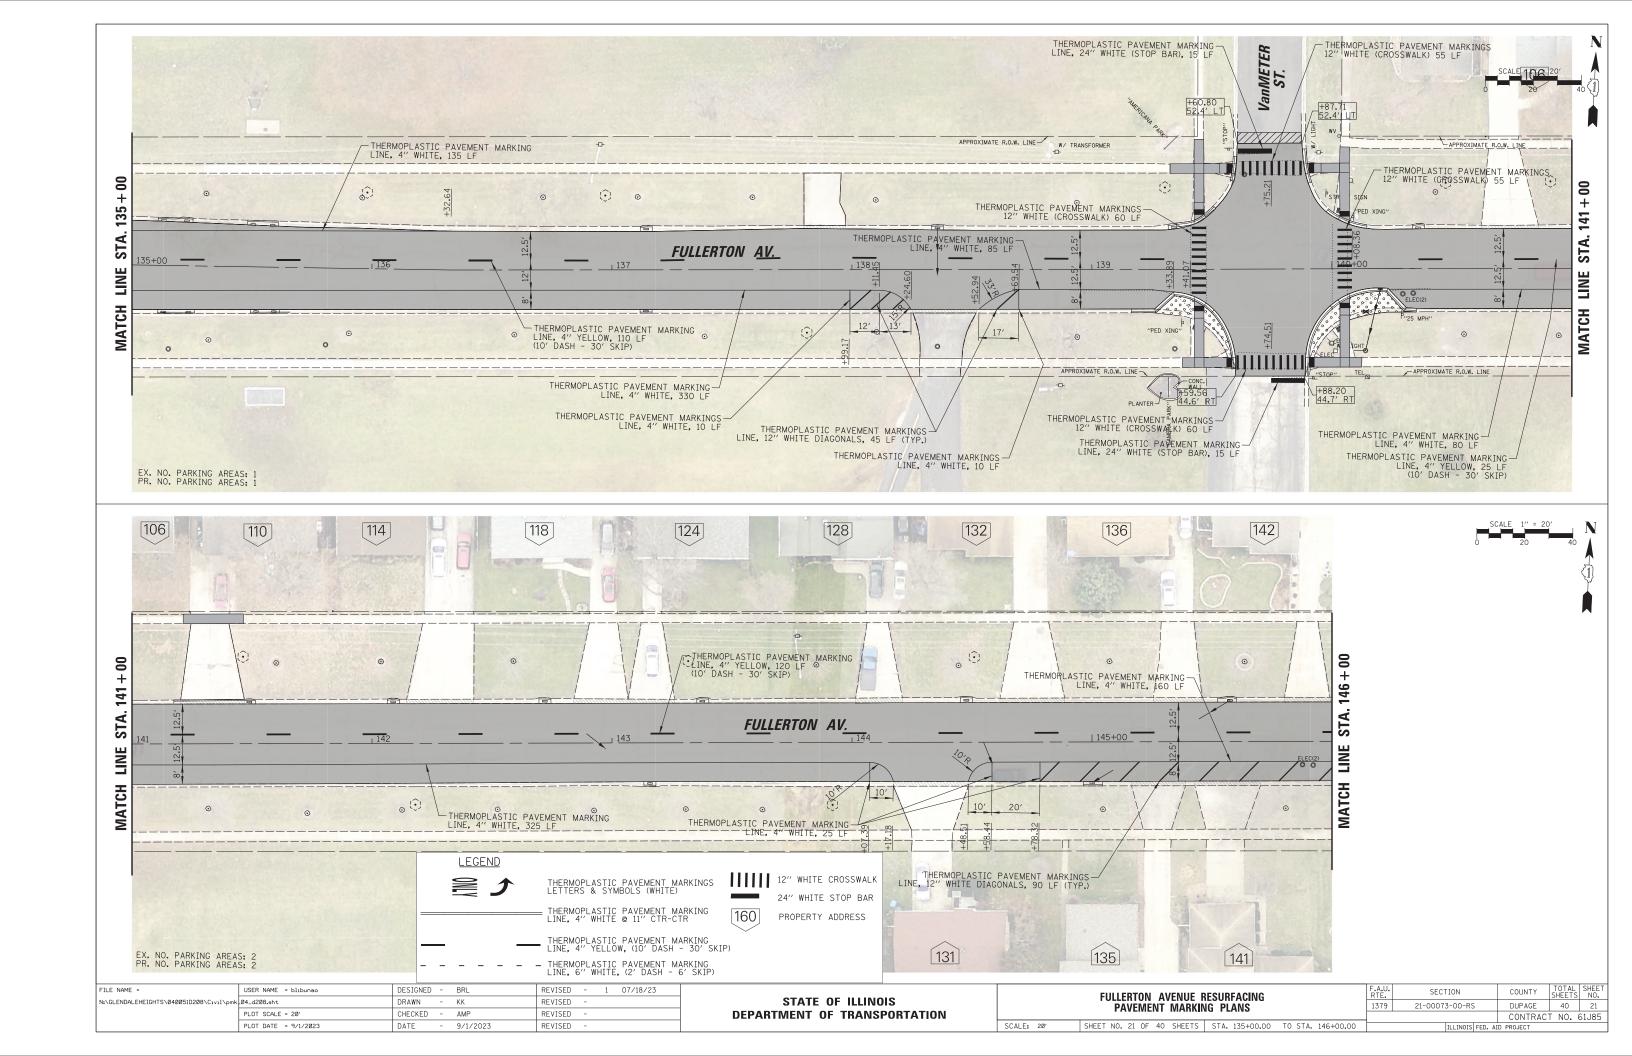


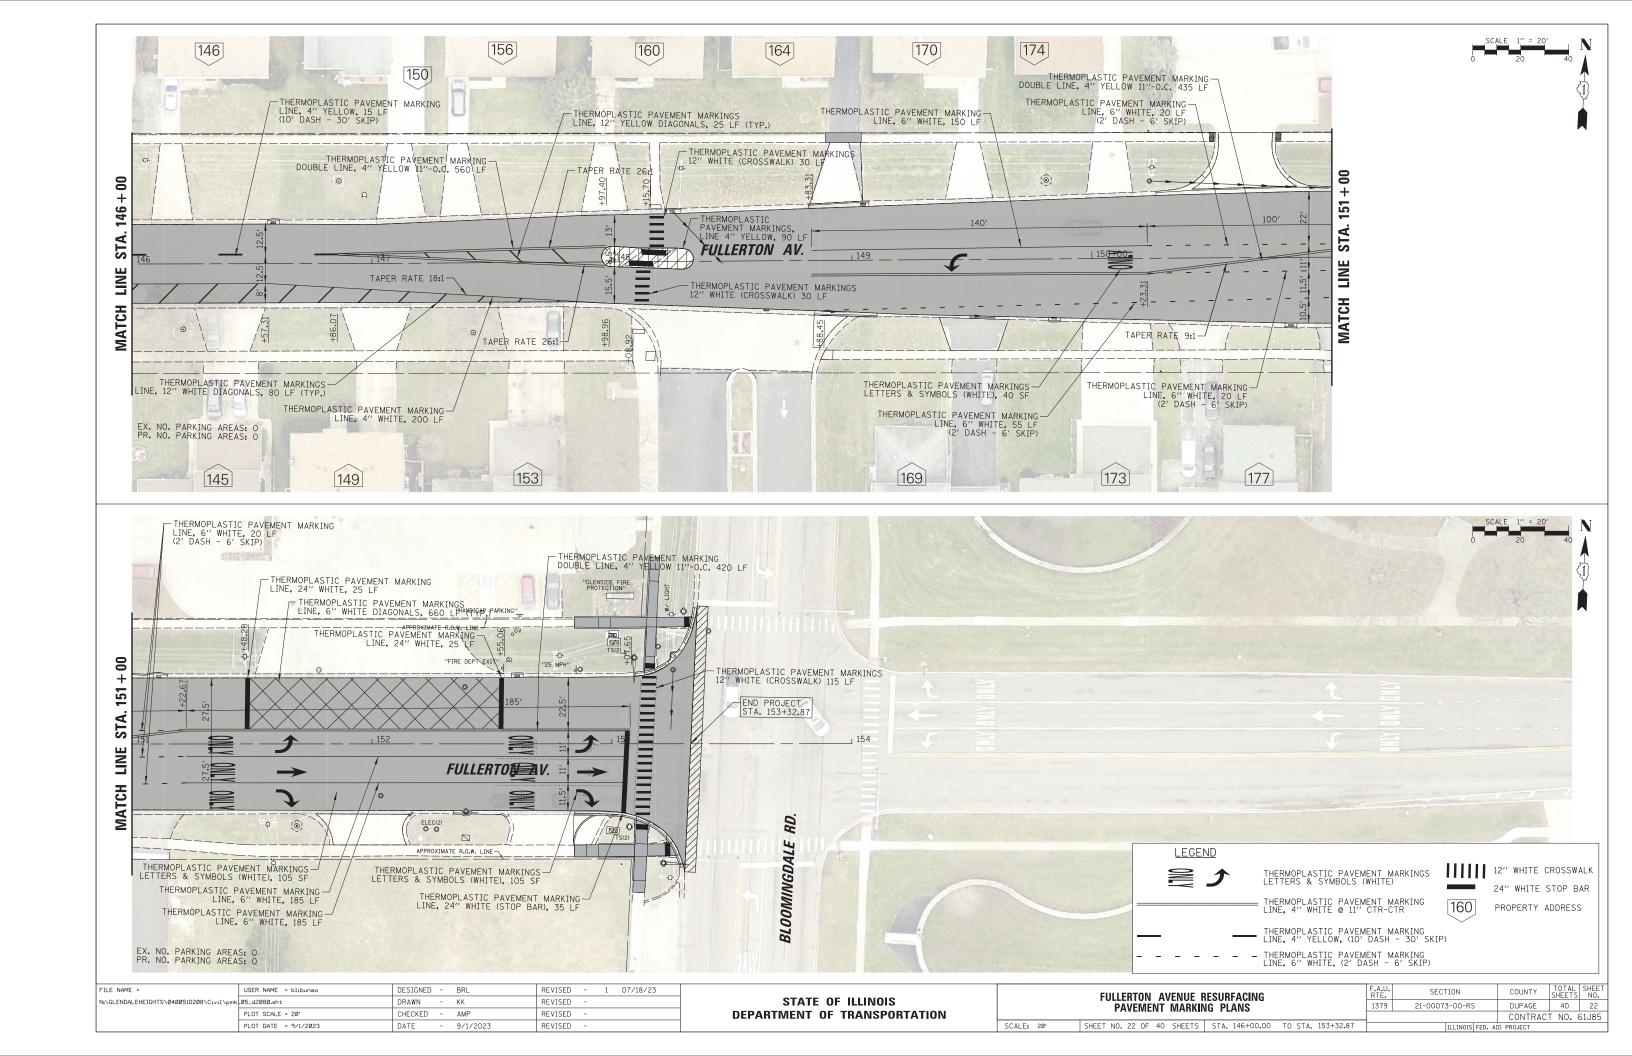


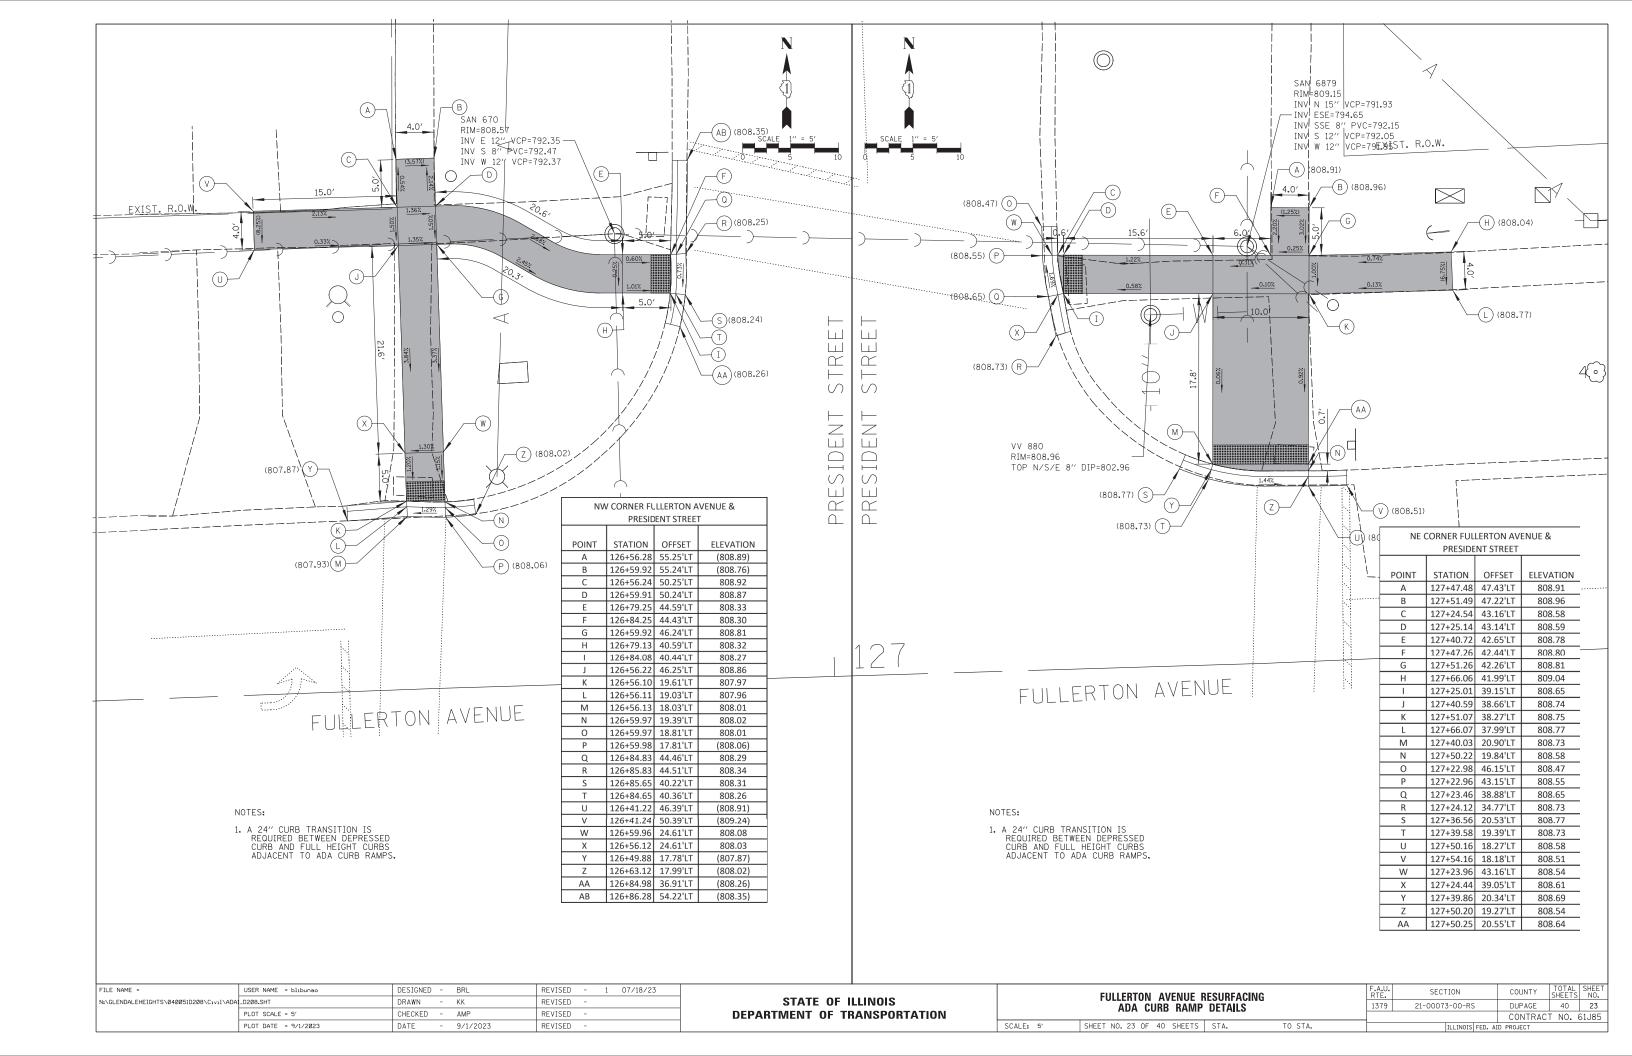


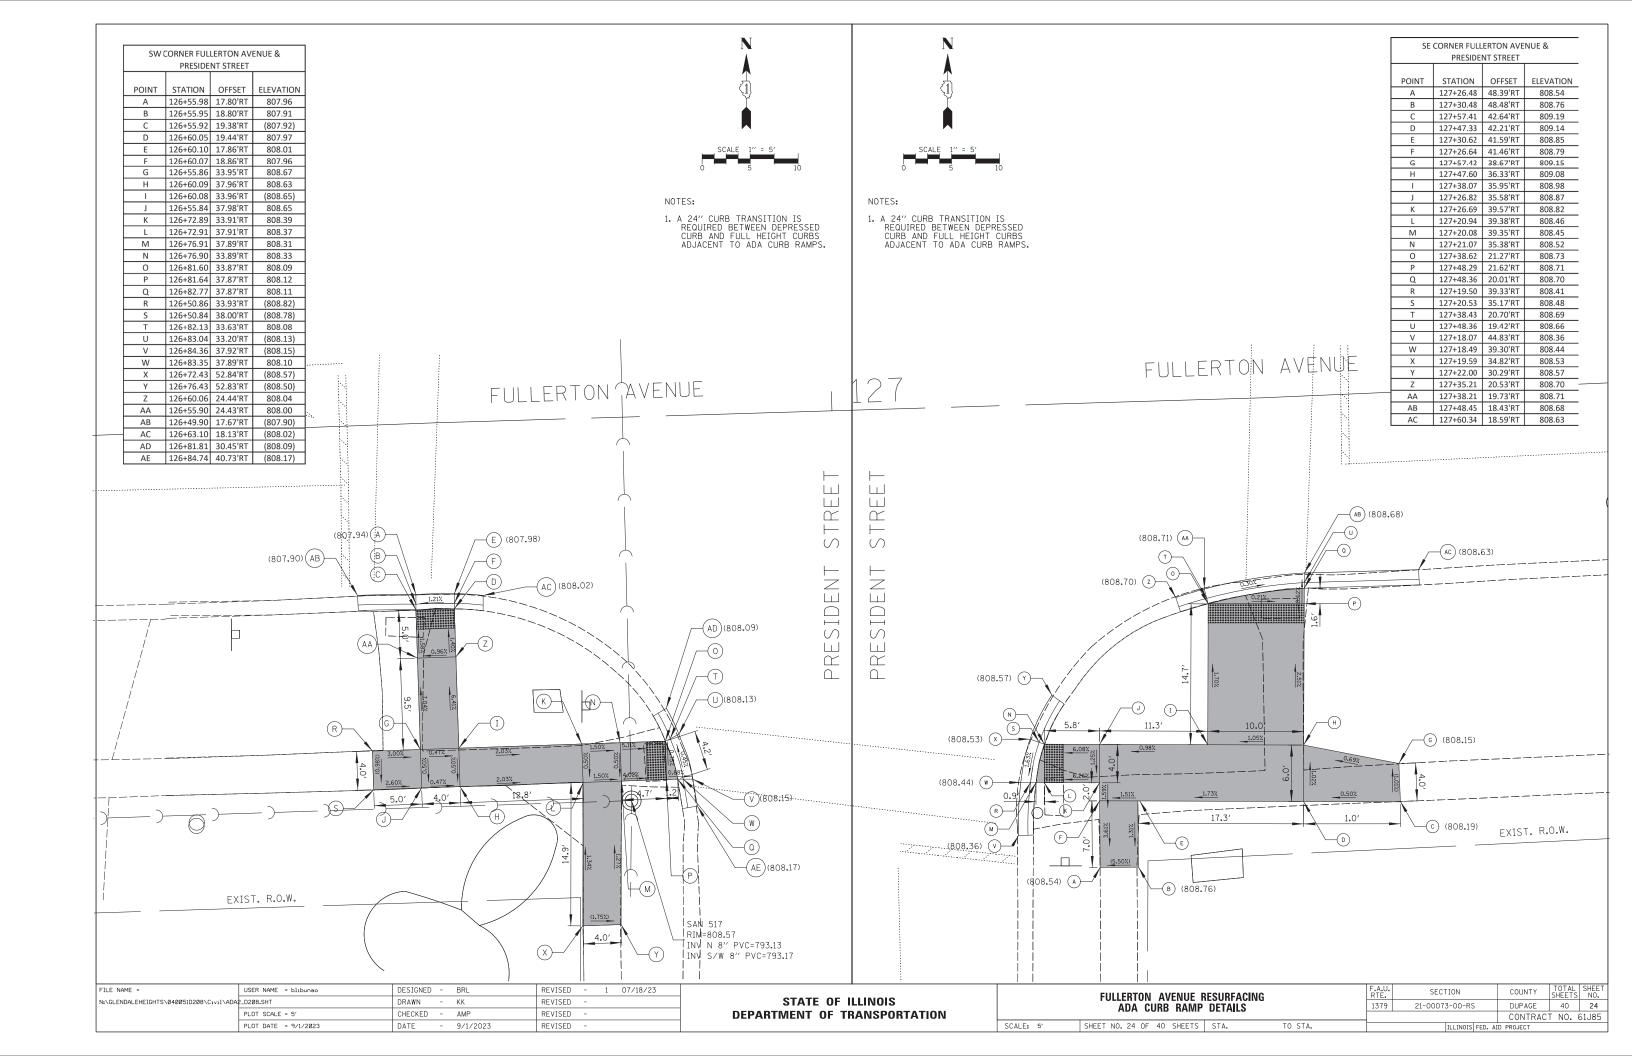


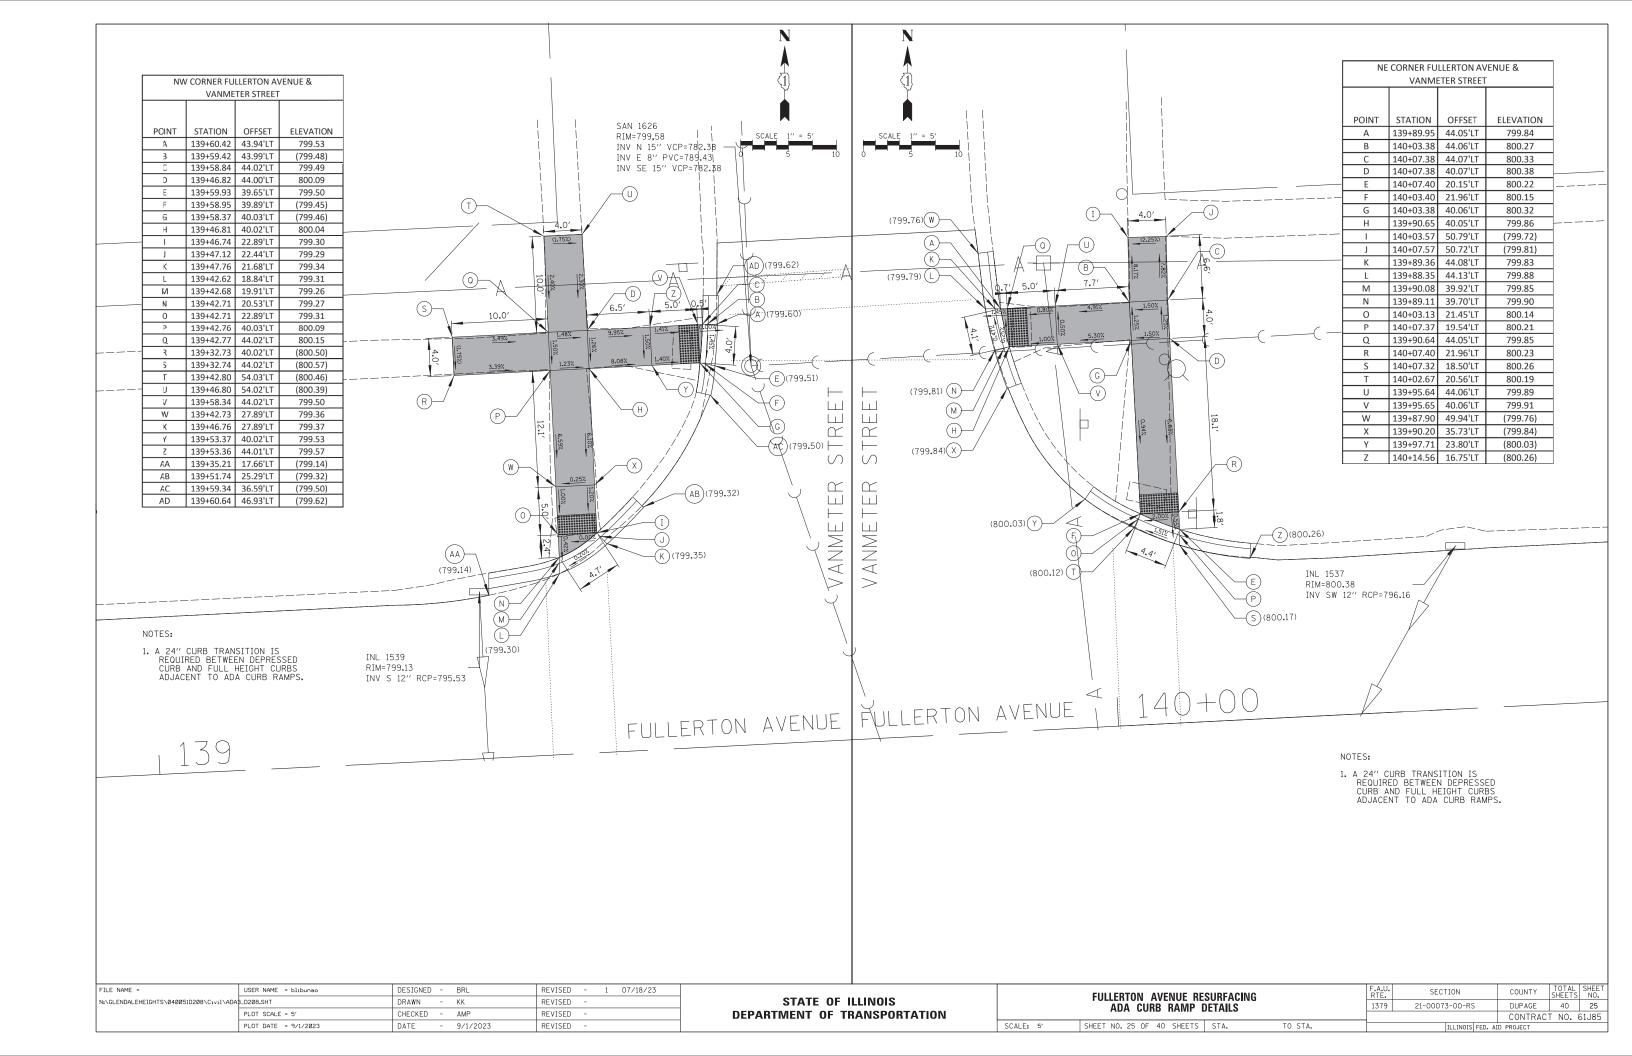


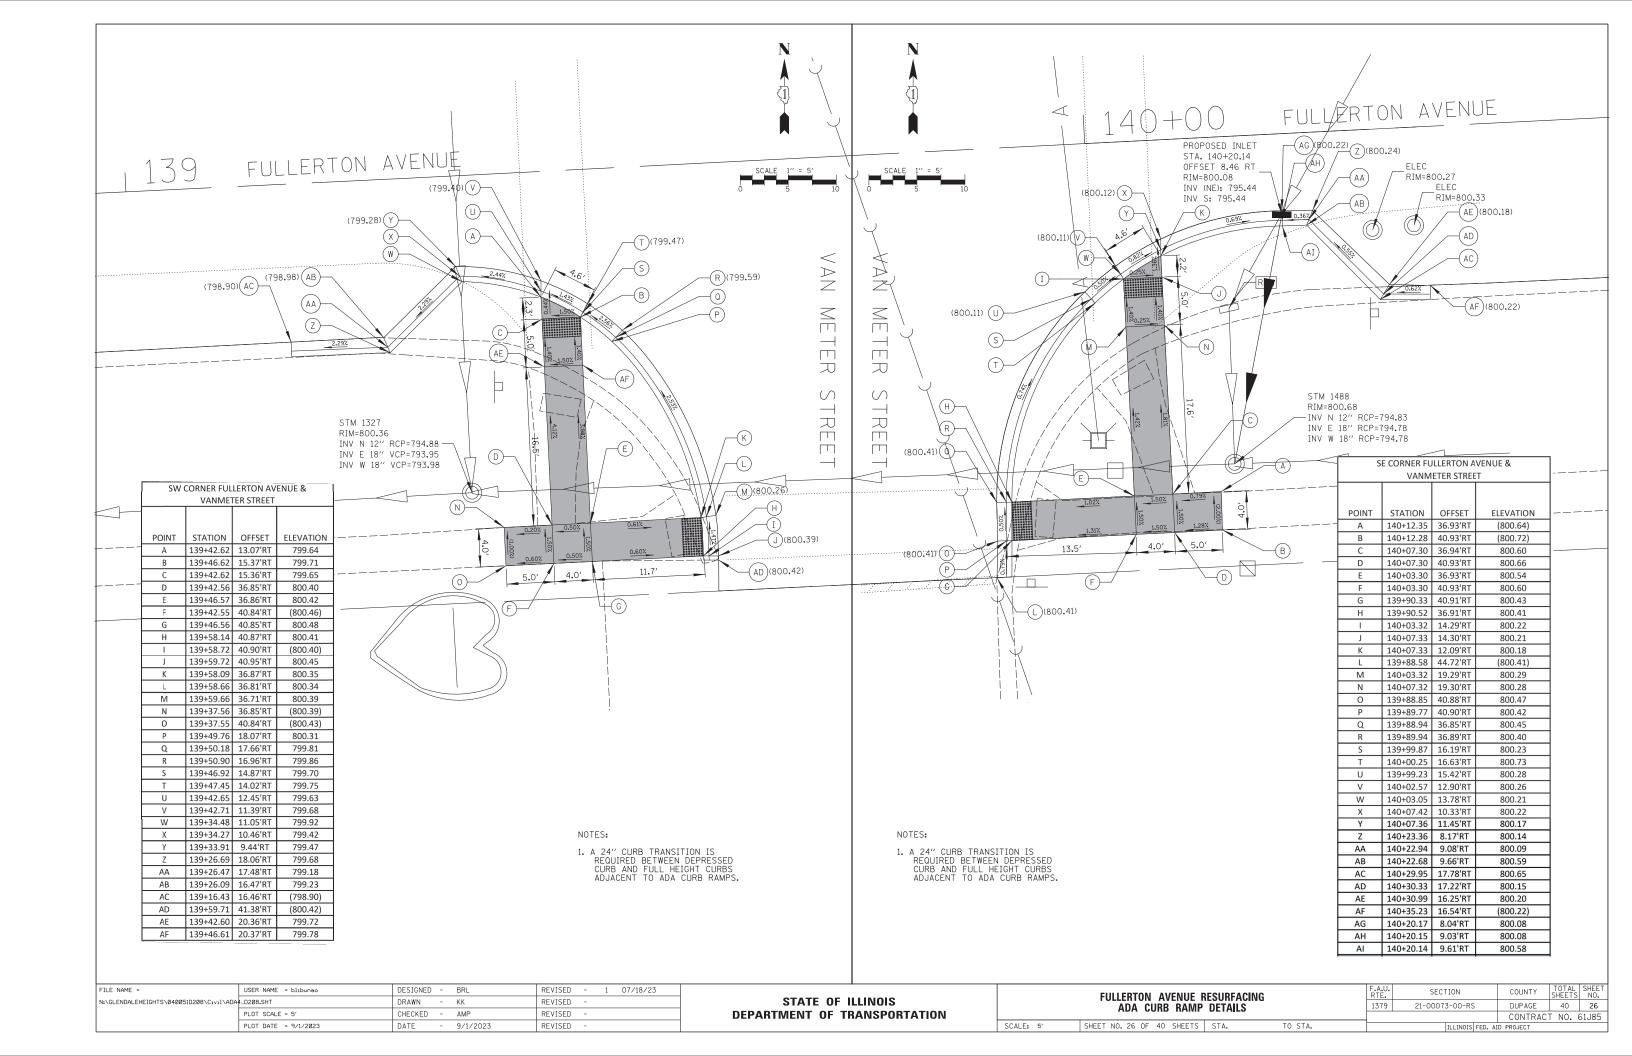


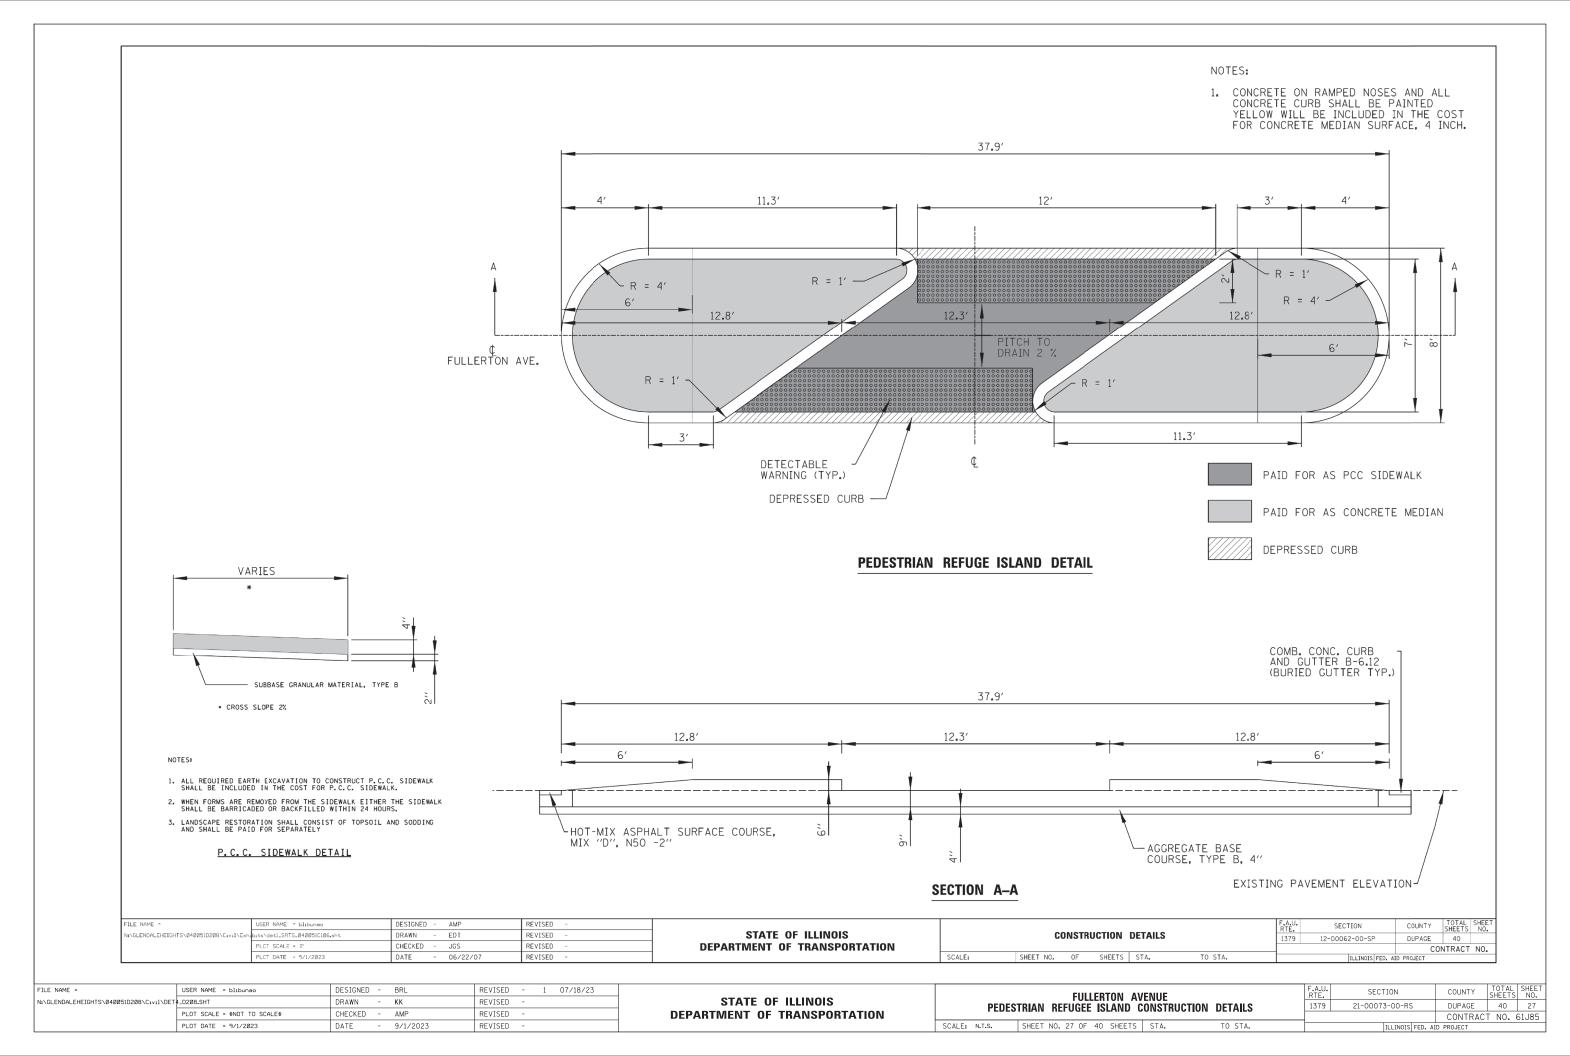


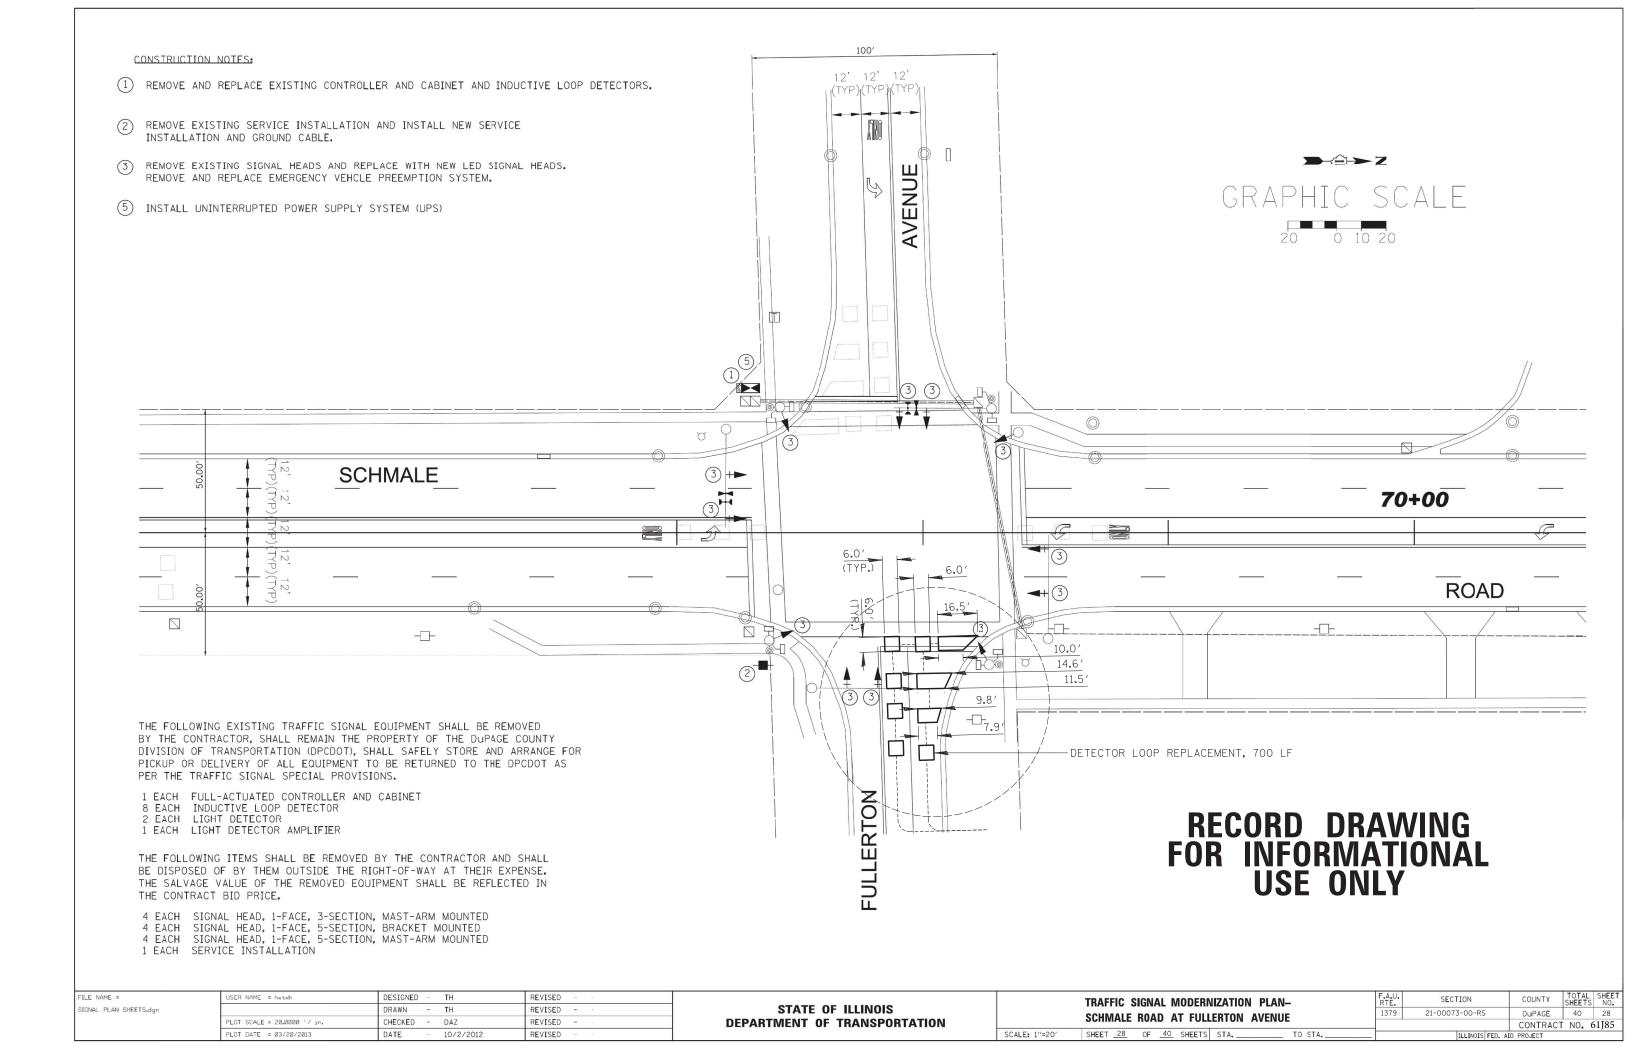

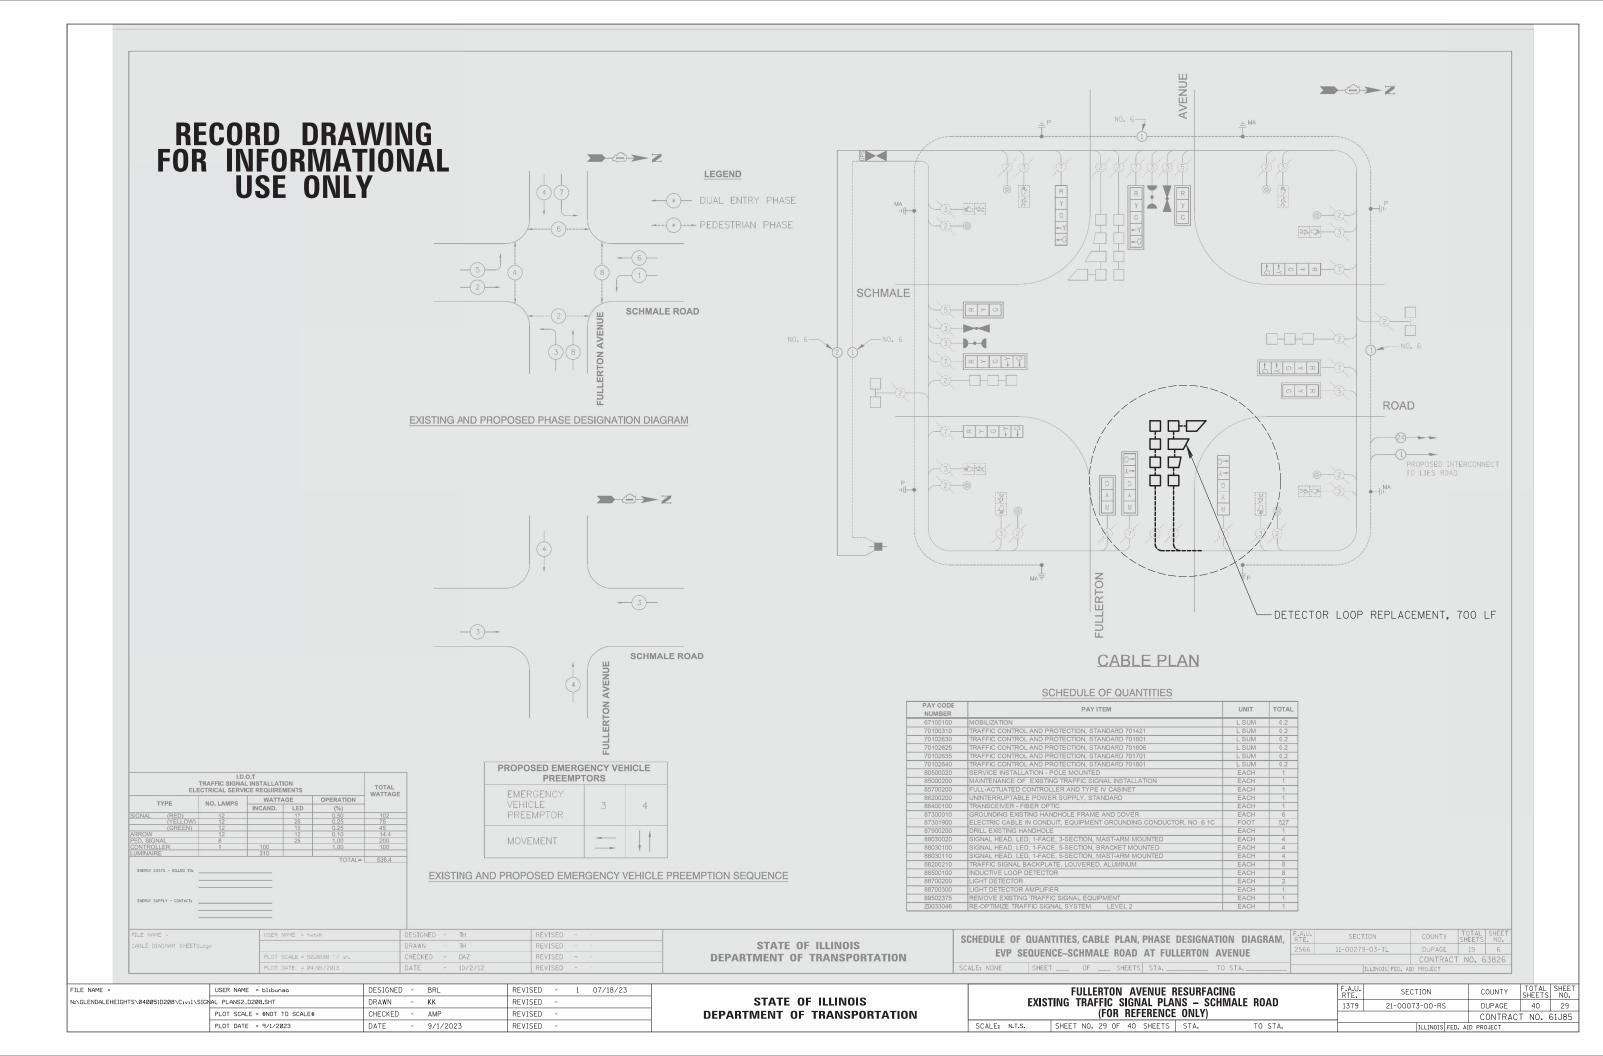

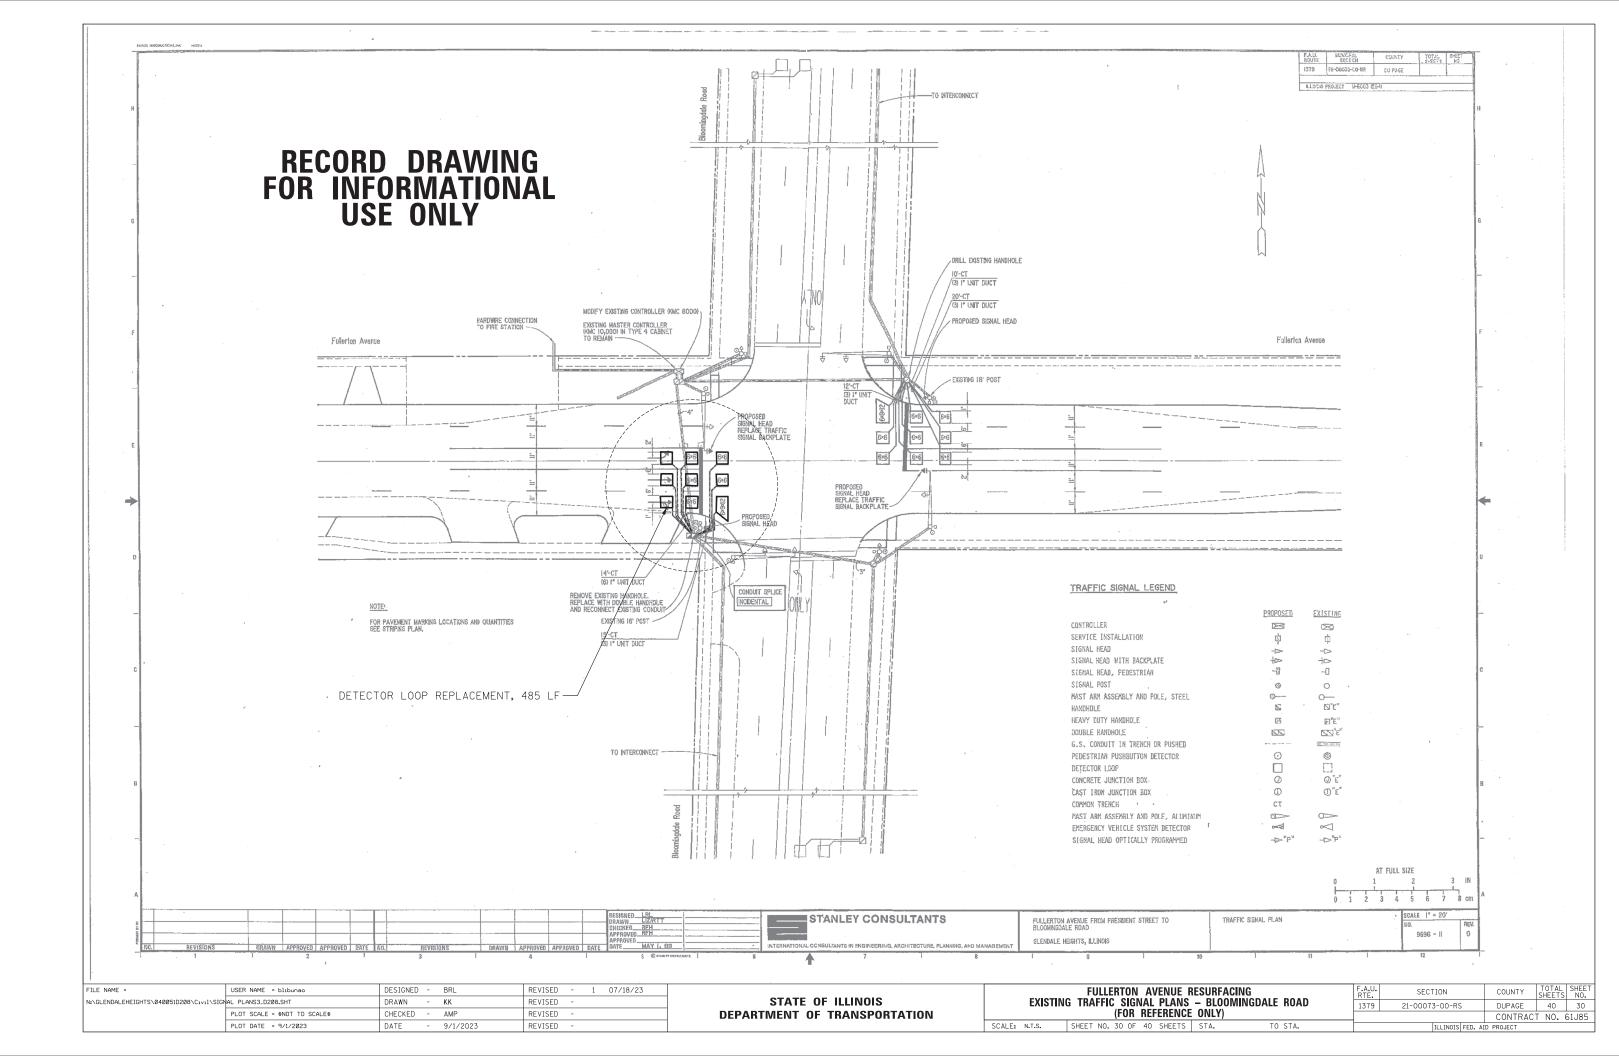

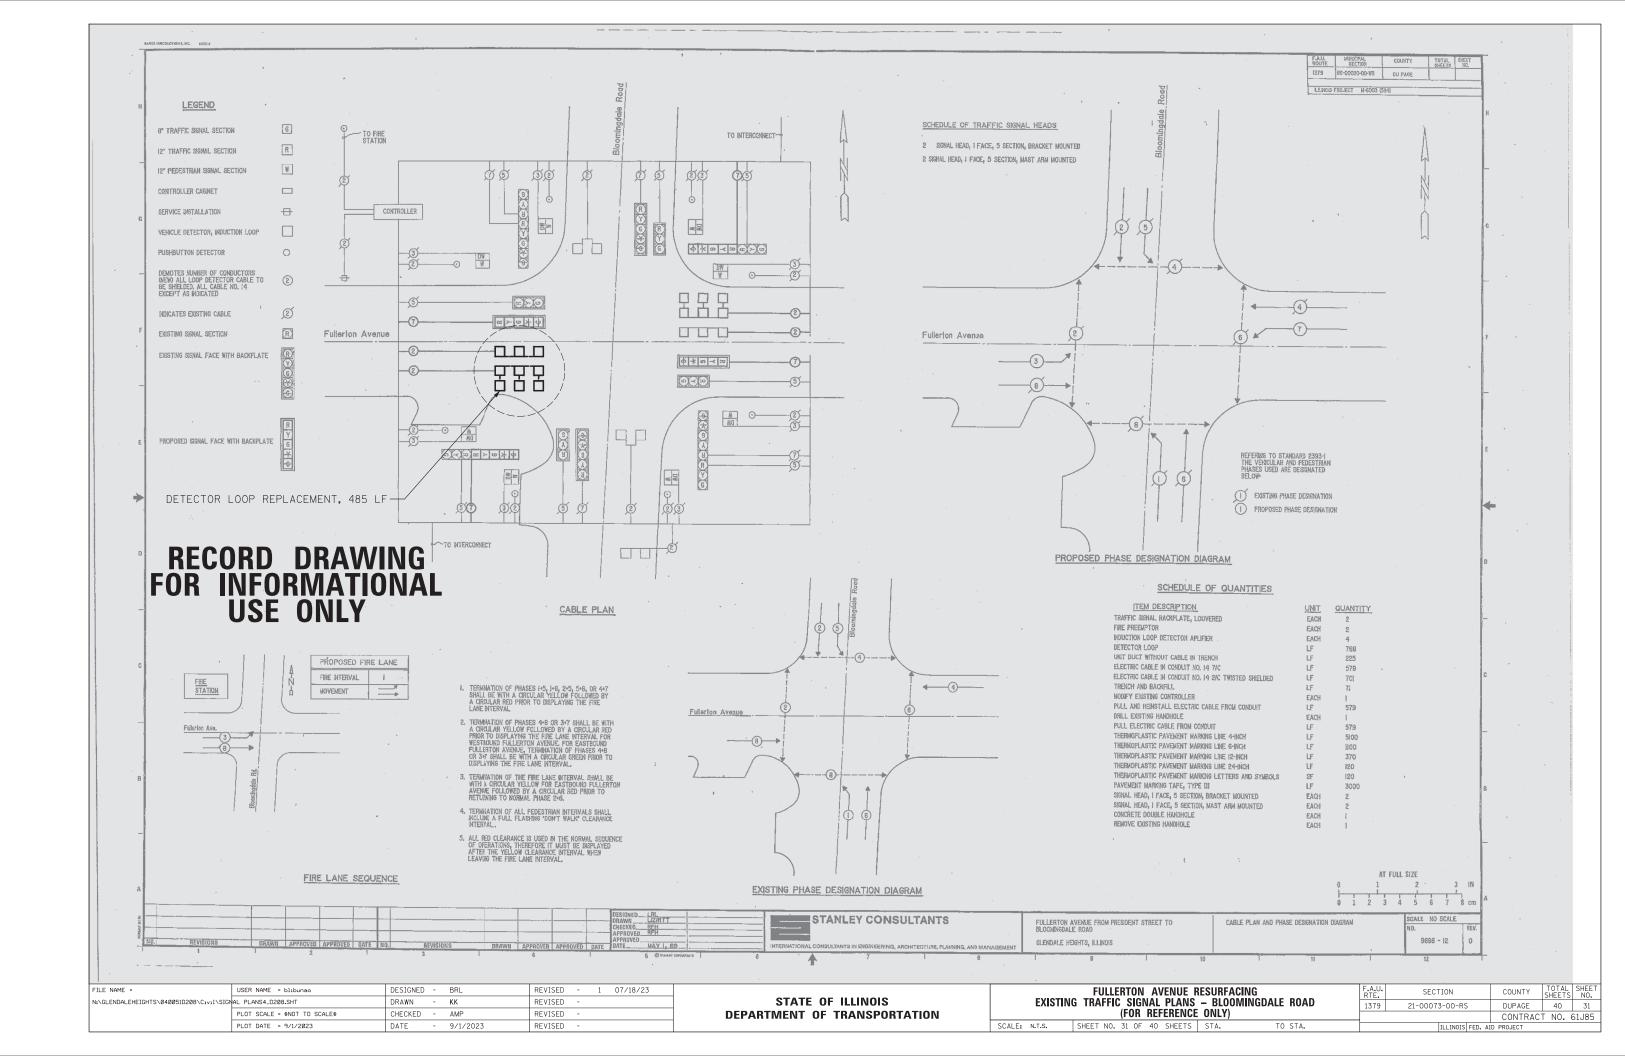

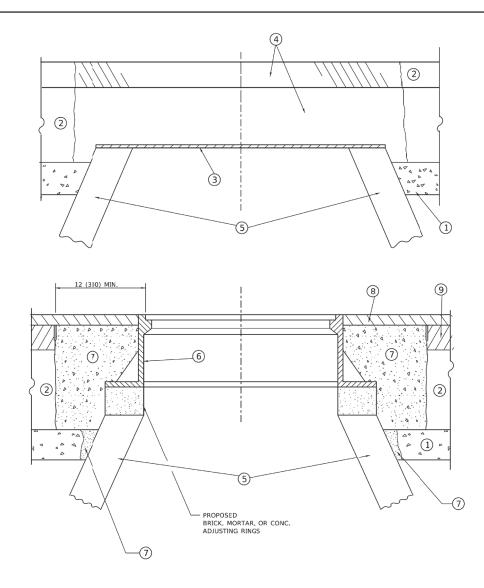

DETAILS FOR FRAMES AND LIDS ADJUSTMENT WITH MILLING

NOTES

- 1. EXISTING BROKEN FRAMES AND LIDS SHALL BE REMOVED AND DISPOSED OF BY THE CONTRACTOR AND SHALL BE REPLACED AS DIRECTED BY THE ENGINEER. REPLACEMENT FRAMES AND LIDS WILL BE PAID FOR IN ACCORDANCE WITH ARTICLE 109.04 OF THE STANDARD SPECIFICATIONS UNLESS A SEPARATE PAY ITEM HAS BEEN PROVIDED.
- 2. IF THE EXISTING LIDS ARE OPEN, THE FRAME WILL BE ADJUSTED TO THE ELEVATION OF THE MILLED PAVEMENT SURFACE PRIOR TO THE MILLING OPERATION. THE FRAME WILL NOT BE REMOVED AND COVERED BY THE METAL PLATE.
- CITY OF CHICAGO CASTINGS ARE THE PROPERTY OF THE CITY AND THE CONTRACTOR SHALL NOTIFY THE CITY FOR REMOVAL AND DISPOSITION OF THE CASTINGS.
- 4. THE METAL PLATE USED TO COVER THE STRUCTURE SHALL REMAIN THE PROPERTY OF THE CONTRACTOR.

CONSTRUCTION PROCEDURES

- STAGE 1 (BEFORE PAVEMENT MILLING)
 - A) REMOVE A MINIMUM OF 12 (300) OF THE PAVEMENT FROM AROUND THE STRUCTURE.
 - B) REMOVE THE EXISTING FRAME AND LID FROM THE STRUCTURE.
 - C) COVER THE STRUCTURE OPENING WITH A 36 (900) DIAMETER METAL PLATE.
 - D) BACKFILL WITH CRUSHED STONE AND HMA SURFACE MIX APPROVED BY THE ENGINEER. (MIN. 1 1/2 (40) HMA TO REMAIN AFTER MILLING).

STAGE 2 (AFTER PAVEMENT MILLING)

- A) REMOVE THE HMA SURFACE MIX AND CRUSHED STONE.
- B) INSTALL THE FRAME AND LID; ADJUST THE FRAME TO ITS FINAL SURFACE ELEVATION.
- C) THE SURROUNDING SPACE SHALL BE FILLED WITH CLASS*PP-1 CONCRETE TO THE ELEVATION OF THE SURFACE OF THE EXISTING BASE COURSE OR THE BINDER COURSE.
- *UNLESS OTHERWISE SPECIFIED IN THE PLANS.

THE PROCEDURE EXPLAINED ABOVE SHALL CONFORM TO THE APPLICABLE PORTIONS OF SECTIONS 353, 406, 602, AND 603 OF THE STANDARD SPECIFICATIONS EXCEPT THAT "THE CONTRACTOR SHALL ADJUST THE STRUCTURES TO THE FINISHED PAVEMENT ELEVATION NO MORE THAN 5 CALENDAR DAYS PRIOR TO PLACEMENT OF THE FINAL LIFT OF SURFACE UNLESS APPROVED BY THE ENGINEER."

LEGEN

① SUB-BASE GRANULAR MATERIAL

(6) FRAME AND LID (SEE NOTES)

② EXISTING PAVEMENT

7 CLASS*PP-1 CONCRETE

3 36 (900) DIAMETER METAL PLATE

(METAL PLATE

8 PROPOSED HMA SURFACE COURSE

PROPOSED CRUSHED STONE AND HMA SURFACE MIX

(5) EXISTING STRUCTURE

PROPOSED HMA BINDER COURSE

LOCATION OF STRUCTURES

THE CONTRACTOR WILL BE REQUIRED TO KEEP A RECORD OF THE LOCATIONS OF THE BURIED STRUCTURES ACCORDING TO THE STATION AND DISTANCE LEFT OR RIGHT OF THE CENTERLINE OF PAVEMENT. UPON COMPLETION OF THE WORK, THE CONTRACTOR WILL DELIVER THE RECORD TO THE ENGINEER.

BASIS OF PAYMENT

- 1. REMOVING FRAMES AND LIDS ON DRAINAGE AND UTILITY STRUCTURES IN THE PAVEMENT PRIOR TO MILLING, AND ADJUSTING TO FINAL GRADE PRIOR TO PLACING THE SURFACE COURSE, WILL BE PAID FOR AT THE CONTRACT UNIT PRICE EACH FOR "FRAMES AND LIDS TO BE ADJUSTED (SPECIAL)."
- 2. THIS WORK WILL NOT BE PAID FOR WHEN DRAINAGE AND UTILITY STRUCTURES ARE SPECIFIED FOR PAYMENT AS STRUCTURE RECONSTRUCTION.
- 3. NEW FRAMES AND LIDS, WHEN SPECIFIED, WILL BE PAID FOR SEPARATELY.
- 4. WHEN STRUCTURES ARE TO BE ADJUSTED OR RECONSTRUCTED, THE LOWERING AND RAISING OF THE FRAMES AND LIDS WILL NOT BE PAID FOR SEPARATELY BUT WILL BE INCLUDED IN THE COST OF THE CORRESPONDING PAY ITEM.

ALL DIMENSIONS ARE IN INCHES (MILLIMETERS) UNLESS OTHERWISE SHOWN

JSER NAME = Lawrence, DeManche DESIGNED - R. SHAH REVISED - R. BORO 01-01-07 **DETAILS FOR** STATE OF ILLINOIS DRAWN REVISED - R. BORO 03-09-11 FRAMES AND LIDS ADJUSTMENT WITH MILLING PLOT SCALE = 100.0000 ' / in CHECKED REVISED - R. BORO 12-06-11 **DEPARTMENT OF TRANSPORTATION** BD600-03 (BD-08) CONTRACT NO. K. SMITH 11-18-22 SCALE: NONE SHEET 1 OF 1 SHEETS STA.

SCALE: \$N.T.S.\$

FILE NAME =	USER NAME = blibunao	DESIGNED	-	BRL	REVISED -	-	Ī
N:\GLENDALEHEIGHTS\040051D208\C1v1\\STE	BD600-03 (BD-8)_D208.SHT	DRAWN	-	KK	REVISED -	-	
	PLOT SCALE = 22'	CHECKED	-	AMP	REVISED -	-	
	PLOT DATE = 9/1/2023	DATE	-	9/1/2023	REVISED -	-	

STATE OF ILLINOIS DEPARTMENT OF TRANSPORTATION

								1
	DETAILS FO)R	F.A.U. RTE.	SECTION	COUNTY	TOTAL SHEETS	SHEET NO.	
FR/	AMES AND LIDS ADJUSTA		1379	21-00073-00-RS	DUPAGE	40	32	
					CONTRA	CT NO.	61J85	
	CHEET NO 32 OF 40 CHEETC	CTA TO CTA			<u></u>			1

METHOD OF MEASUREMENT


REFER TO SECTION 442 OF THE STANDARD SPECIFICATIONS FOR ROAD AND BRIDGE CONSTRUCTION AND THE RECURRING SPECIAL PROVISION "PATCHING WITH HOT-MIX ASPHALT OVERLAY REMOVAL."

BASIS OF PAYMENT

- 1. REFER TO SECTION 442 OF THE STANDARD SPECIFICATIONS FOR ROAD AND BRIDGE CONSTRUCTION AND THE RECURRING SPECIAL PROVISION "PATCHING WITH HOT-MIX ASPHALT OVERLAY REMOVAL."
- 2. SAW CUT/SCORING OF EXISTING HMA OVERLAY IS INCLUDED IN THE COST OF PAVEMENT PATCHING.
- 3. SAW CUT/SCORING OF EXISTING PAVEMENT IS INCLUDED IN THE COST OF PAVEMENT PATCHING.

* SEE TYPICAL SECTIONS FOR

THICKNESS AND MATERIALS

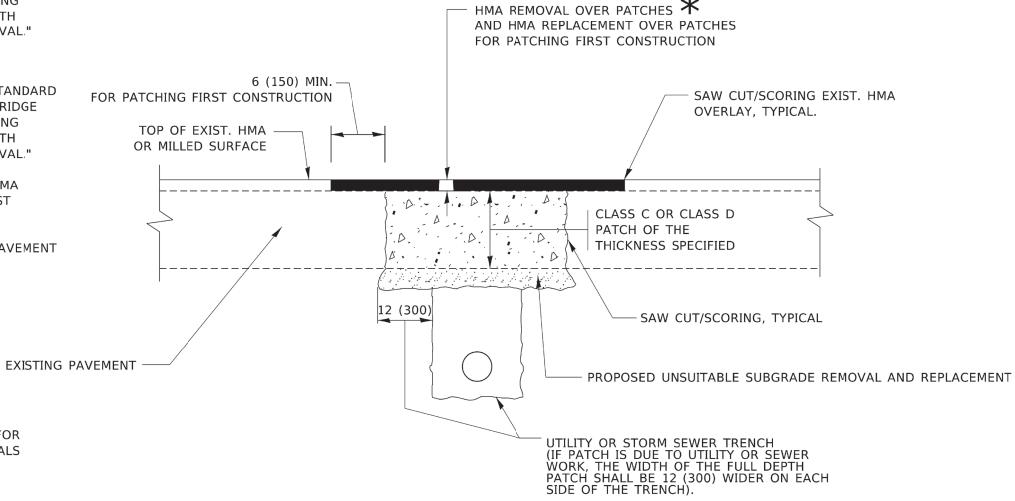

SEQUENCE OF CONSTRUCTION (PATCHING FIRST)

- 1. REMOVE THE EXISTING HMA MATERIAL OVER THE AREA TO BE PATCHED.
- 2. REMOVE AND REPLACE WITH CLASS C OR D PATCH.
- 3. REPLACE HMA MATERIAL OVER THE AREA TO BE PATCHED.


SEQUENCE OF CONSTRUCTION (MILLING FIRST)

- 1. MILL HMA FIRST IF THERE IS AT LEAST 4½ INCHES OR MORE OF HMA MATERIAL ON TOP OF THE EXISTING PAVEMENT OR IF THE PAVEMENT IS FULL DEPTH HMA. A MINIMUM OF 2 INCHES OF HMA MATERIAL SHALL BE IN PLACE AFTER MILLING.
- 2. REMOVE AND REPLACE WITH FULL DEPTH CLASS D PATCHES TO TOP OF MILLED SURFACE.

ALL DIMENSIONS ARE IN INCHES (MILLIMETERS) UNLESS OTHERWISE SHOWN.

USER NAME = Lawrence.DeManche	DESIGNED - R. SHAH	REVISED - R. BORO 01-01-07		PAVEMENT PATCHING FOR	F.A. RTF	SECTION	COUNTY	TOTAL SHEET
	DRAWN -	REVISED - R. BORO 09-04-07	STATE OF ILLINOIS		11121		·	JANUARY NO.
PLOT SCALE = 100.0000 ' / in.	CHECKED -	REVISED - K. ENG 10-27-08	DEPARTMENT OF TRANSPORTATION	HMA SURFACED PAVEMENT		BD400-04 (BD-22)	CONTRACT	Γ NO.
PLOT DATE = 11/18/2022	DATE - 10-25-94	REVISED - K. SMITH 11-18-22		SCALE: NONE SHEET 1 OF 1 SHEETS STA. TO STA.		ILLINOIS FED. AI	D PROJECT	

FILE NAME =	USER NAME = blibunao	DESIGNED - BRL	REVISED -		PAVEMENT PATCHING FOR	F.A.U.	SECTION	COUNTY TOTA	AL SHEET
N:\GLENDALEHEIGHTS\040051D208\C1v1\STD	BD400-04 (BD-22)_D208.SHT	DRAWN - KK	REVISED -	STATE OF ILLINOIS	HMA SURFACED PAVEMENT	1379	21-00073-00-RS	DUPAGE 40	33
	PLOT SCALE = 20'	CHECKED - AMP	REVISED -	DEPARTMENT OF TRANSPORTATION	IIMA SOIII AGED I AVENIENT			CONTRACT NO	VO. 61J85
	PLOT DATE = 9/1/2023	DATE - 9/1/2023	REVISED -		SCALE: \$N.T.S.\$ SHEET NO. 33 OF 40 SHEETS STA. TO STA.		TILL INOIS FED. AID	PROJECT	

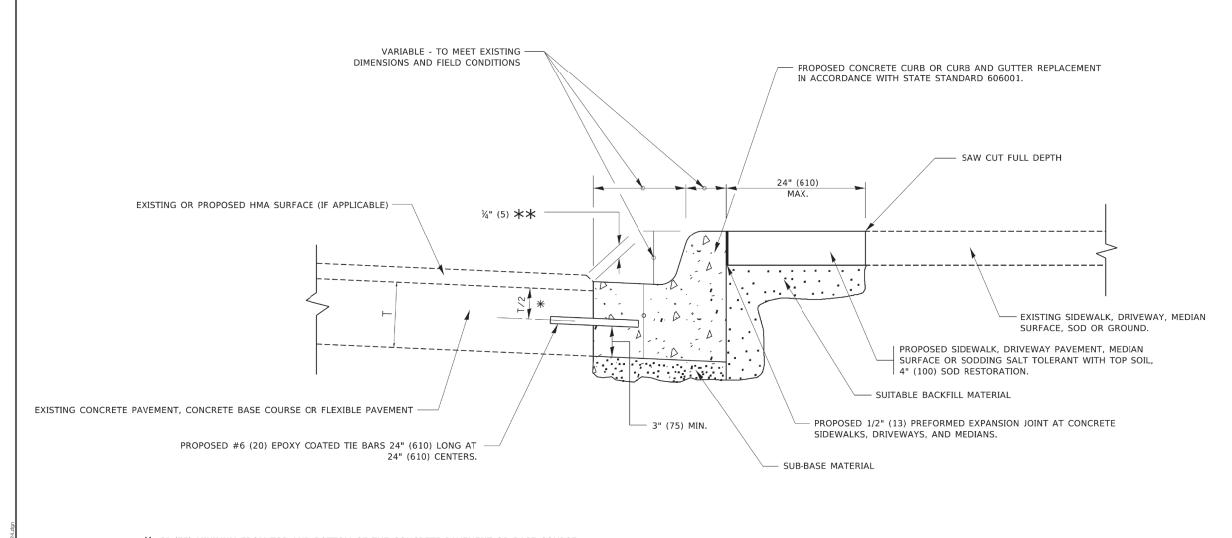


- $\frac{1}{2}$ 3" (75) MINIMUM FROM TOP AND BOTTOM OF THE CONCRETE PAVEMENT OR BASE COURSE.
- $\star\star$ if the final surface of the pavement is concrete, the gutter is to be flush with the pavement.


CURB OR CURB AND GUTTER REMOVAL AND REPLACEMENT


ALL DIMENSIONS ARE IN INCHES (MILLIMETERS) UNLESS OTHERWISE SHOWN.


USER NAME = footemj	DESIGNED - A. HOUSEH	REVISED - A. ABBAS 03-21-97		CURB OR CURB AND GUTTER	F.A.	SECTION	COUNTY TOTAL SHEET SHEETS NO.
	DRAWN -	REVISED - M. GOMEZ 01-22-01	STATE OF ILLINOIS	REMOVAL AND REPLACEMENT			0.1210
PLOT SCALE = 50.0000 ' / in.	CHECKED -	REVISED - R. BORO 12-15-09	DEPARTMENT OF TRANSPORTATION			BD600-06 (BD-24)	CONTRACT NO.
PLOT DATE = 7/11/2019	DATE - 03-11-94	REVISED - K. SMITH 07-11-19		SCALE: NONE SHEET 1 OF 1 SHEETS STA. TO	O STA.	ILLINOIS FED.	AID PROJECT

FILE NAME =	USER NAME = blibunao	DESIGNED -	BRL	REVISED -		CURD OR CURD AND CUTTER	F.A.U.	SECTION	COUNTY	TOTAL SHE	EET
N:\GLENDALEHEIGHTS\040051D208\C1v1\ST	D_BD600 (BD-24)_D208.SHT	DRAWN -	KK	REVISED -	STATE OF ILLINOIS	CURB OR CURB AND GUTTER REMOVAL AND REPLACEMENT	1379	21-00073-00-RS	DUPAGE	40 7	34
	PLOT SCALE = 22'	CHECKED -	AMP	REVISED -	DEPARTMENT OF TRANSPORTATION	NEWOVAL AND NEPLAGEWENT	10.0	21 00010 00 110	CONTRA	CT NO. 61	J85
	PLOT DATE = 9/1/2023	DATE -	9/1/2023	REVISED -		SCALE: \$N.T.S.\$ SHEET NO. 34 OF 40 SHEETS STA. TO STA.		ILLINOIS FED. A	ID PROJECT		

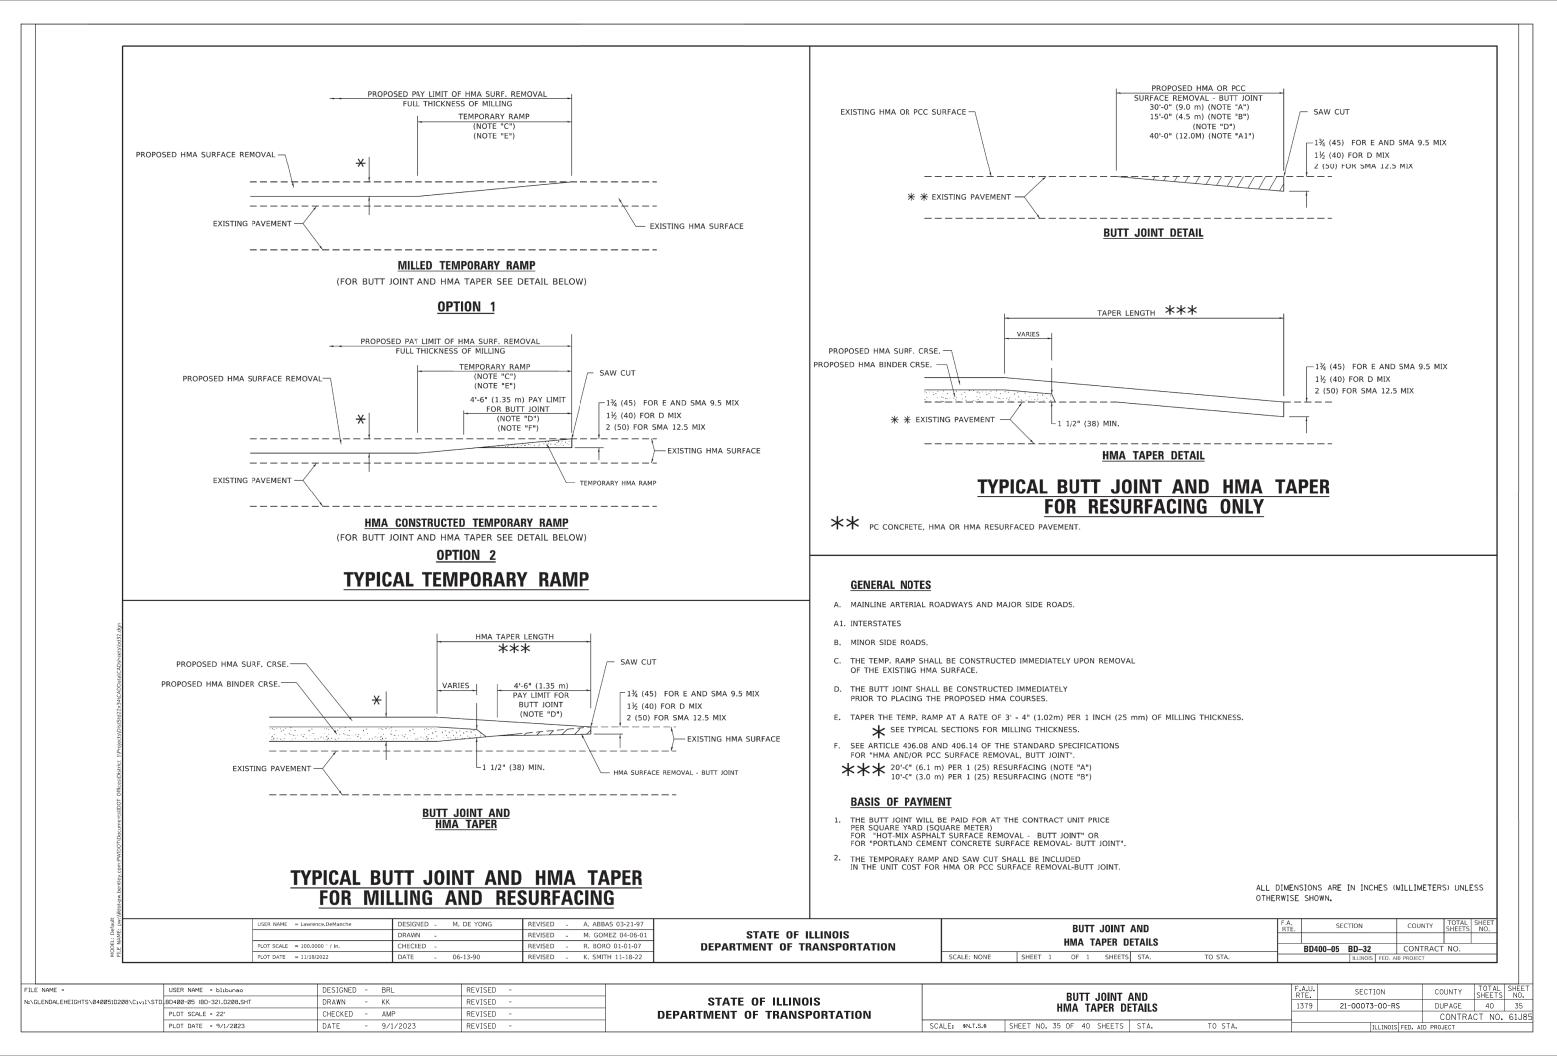

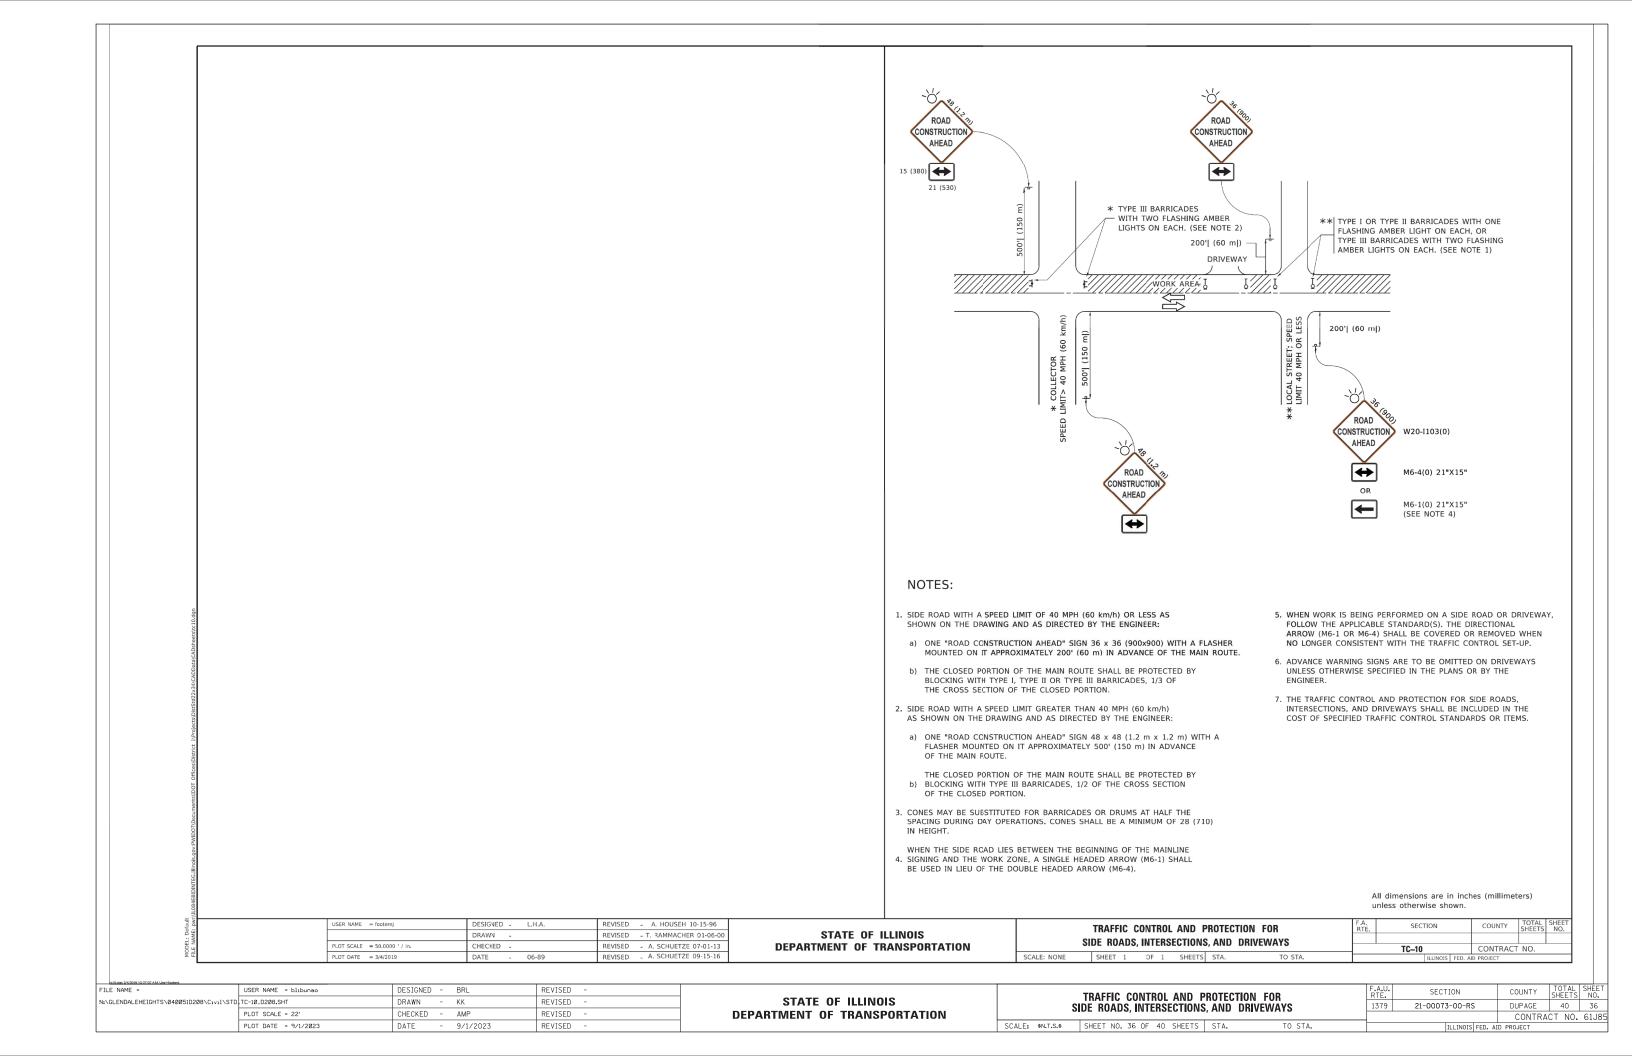

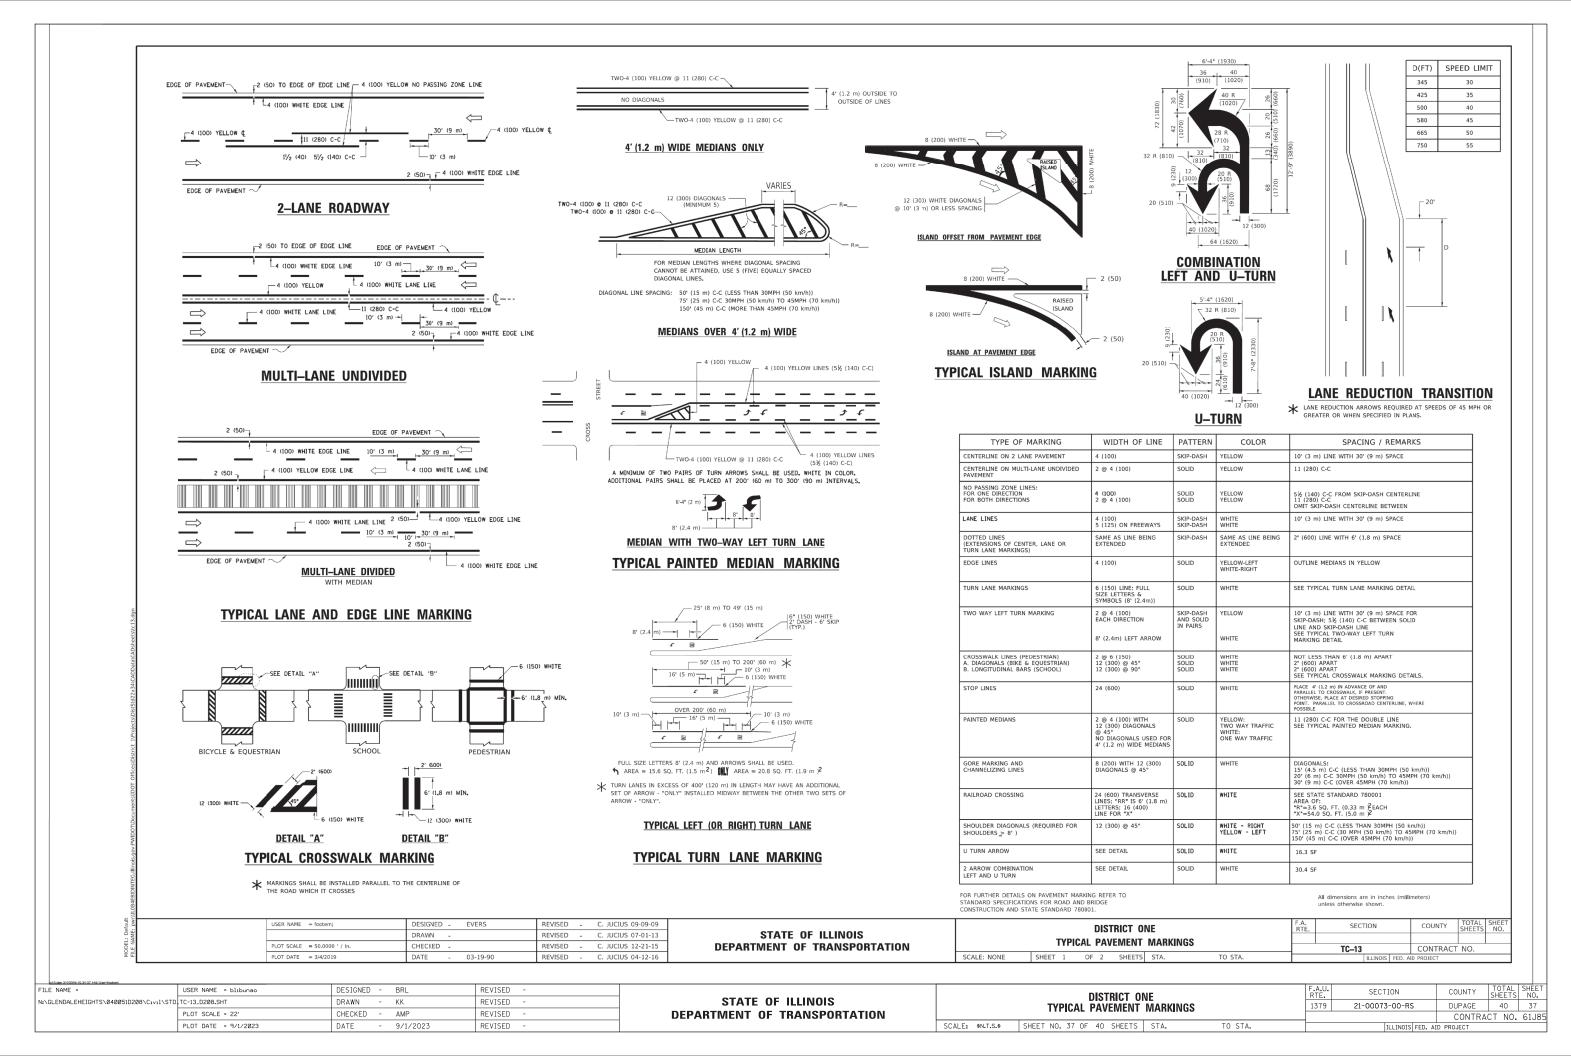

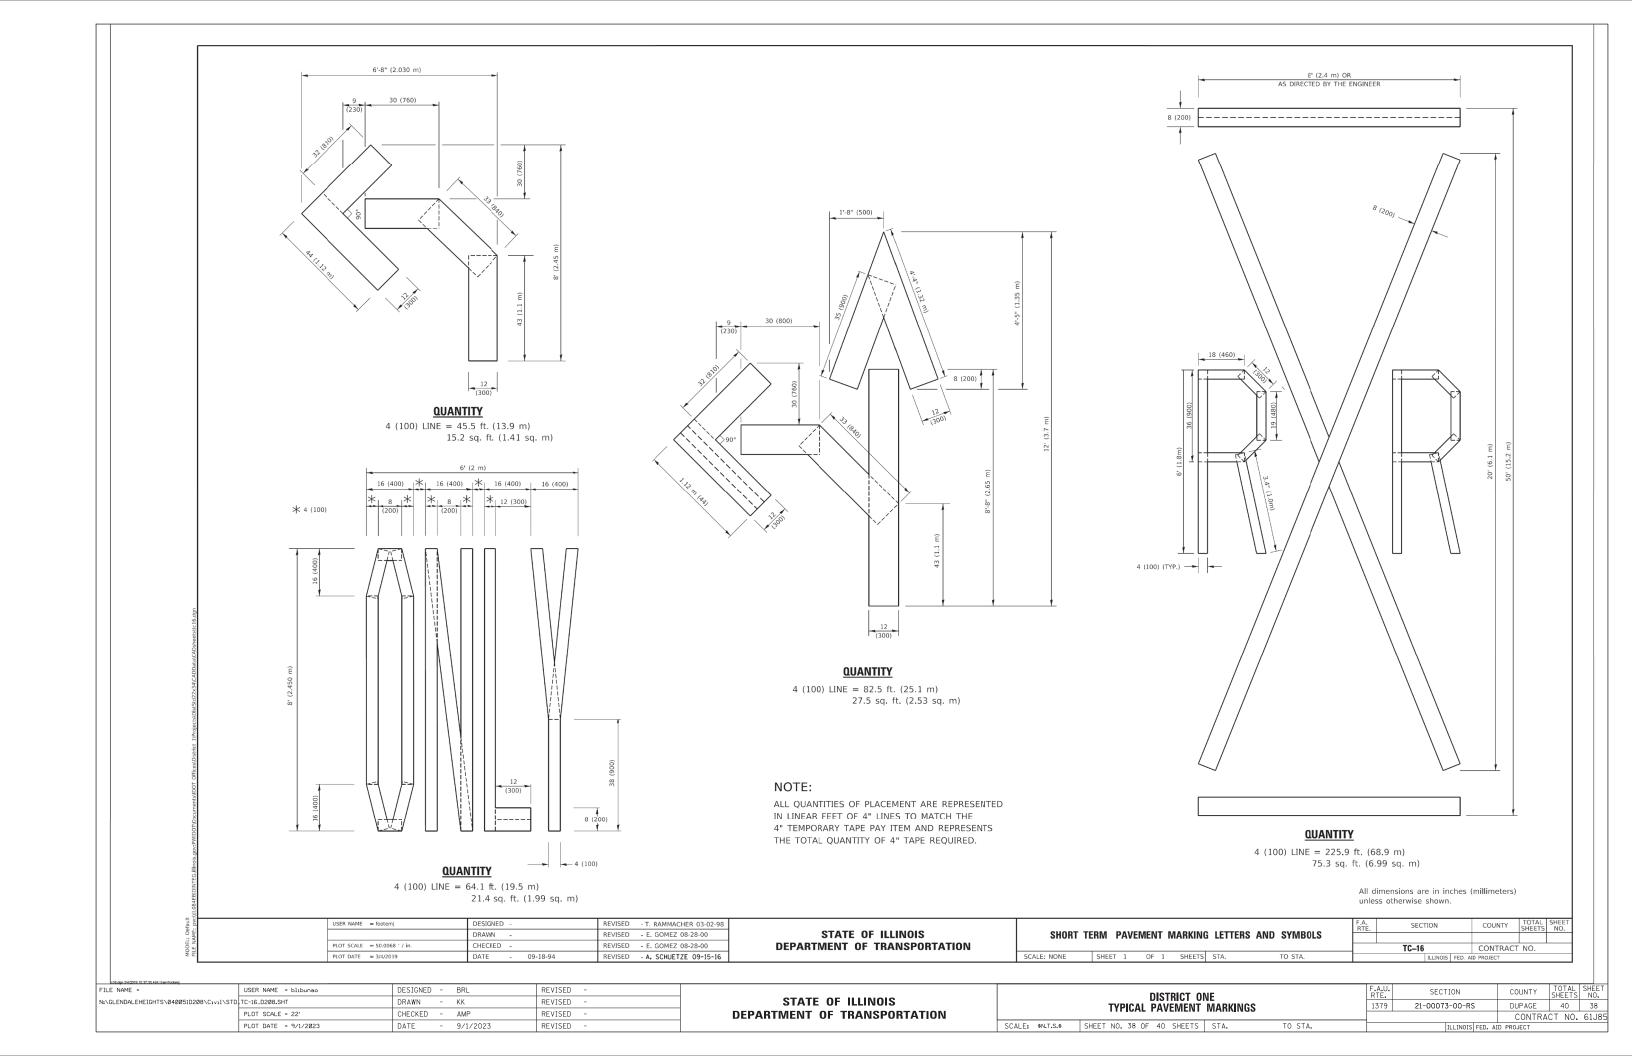

LOOPS NEXT TO SHOULDERS PROVIDE A PAVEMENT REPLACEMENT NOTE WHICH SHOULD EQUAL 3' (900 mm) X WIDTH OF PAVED SHOULDER. NON-PAVED SHOULDER (1.5 m) (1.8 m) (1.5 m) 1" (25 mm) UNIT DUCT-TRENCHED (3.0 m) (3.0 m) TO E/P ** * * UNIT DUCT IS TO BE SHOWN ON PLAN SHEETS BUT SHALL NOT BE INCLUDED IN THE PAY ITEMS ARTERIAL-VOLUME DENSITY ("FAR OUT" DETECTION) CROSS STREET-NON VOLUME DENSITY ("FAR OUT" DETECTION)

** = (1.5m)

LOOPS ARE SAW-CUT TO THE EDGE OF PAVEMENT. 1" (25 mm) UNIT

EDGE OF PAVEMENT

OUTSIDE PAVEMENT)

USER NAME = footen

PLOT SCALE = 50,0000 ' / ir

AND HANDHOLE

(TYP. FOR LOOPS THAT TERMINATE


IN HANDHOLES

DUCT IS RUN BETWEEN

CROSS STREET

LEFT TURN LANES WITH MEDIANS VOLUME DENSITY ("FAR OUT" DETECTION) ON SAME APPROACH (PROTECTED / PERMITTED LEFT TURN PHASING)

HANDHOLE LOCATION MAY VARY DEPENDING ON GEOMETRICS AND DESIGN OF TRAFFIC SIGNALS. HEAVY-DUTY HANDHOLES TO BE USED WHEN THE MEDIAN IS MOUNTABLE. REFER TO STANDARD

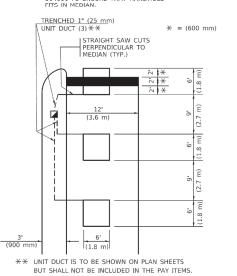

NOTE: DUAL LEFT TURNS NOT SHOWN REFER TO PLAN SHEET FOR DETECTOR LOOP REPLACEMENT

CALLING LOOP IN RIGHT TURN LANE

TYP.-ALL LEGS-VOLUME

OFF SET LOOPS BY

STRAIGHT SAW CUTS

REVISED

REVISED


WAY LOCATION CALLING LOOPS

[TYP.:12' (3.6m) LANES]

LEFT TURN LANES WITHOUT MEDIANS


VOLUME DENSITY ("FAR OUT" DETECTION) ON SAME APPROACH

(PROTECTED / PERMITTED LEFT TURN PHASING)

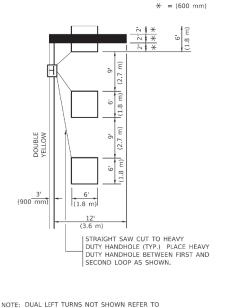

PLAN SHEET FOR DETECTOR LOOP REPLACEMENT

ARTERIAL-VOLUME DENSITY ("FAR OUT" DETECTION) CROSS STREET-NON VOLUME DENSITY ("UPTIGHT" PRESENCE DETECTION)

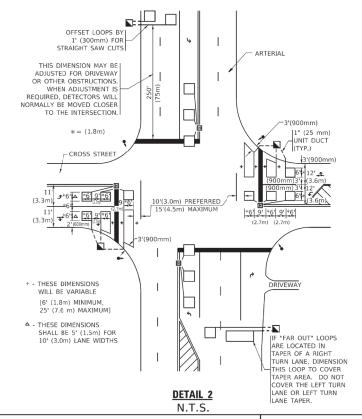

NOTES:

VEHICLES LOOP DETECTORS

- * ALL LEAD IN CABLE SHALL BE TWO CONDUCTOR NO. 14 TWISTED, SHIELDED.
- * EACH DETECTOR LOOP SHALL HAVE ITS OWN SAW CUT FROM THE LOOP TO THE EDGE OF PAVEMENT OR TO A HANDHOLE IN THE PAVEMENT
- * EACH DETECTOR LOOP SHALL HAVE ITS OWN ONE INCH (25 mm) UNIT DUCT BETWEEN THE EDGE OF PAVEMENT AND THE FIRST HANDHOLE OR JUNCTION BOX. EACH UNIT DUCT RUN SHALL BE SHOWN ON THE PLANS BY THE DESIGNER, BUT SHALL NOT BE PAID FOR SEPARATLY, THIS ITEM IS INCIDENTAL TO THE PAY ITEM FOR DETECTOR LOOPS.
- st ONE DIMENSION OF <u>ALL</u> DETECTOR LOOPS SHALL BE SIX FEET (1.8 m)
- * EACH LANE OF NON-LOCKING, PRESENCE DETECTION AND EACH LANE OF A DOUBLE LEFT TURN LANE REQUIRES A SEPARATE INDUCTIVE LOOP DETECTOR AND LEAD IN CABLE.
- * WHEN NON-LOCKING, PRESENCE DETECTION IS USED, MORE THAN ONE LOOP PER LANE IS REQUIRED BEHIND THE STOP BAR (i.e. 1-1/2, 1-3/4, 2).
- * WHEN SYSTEM LOOPS ARE REQUIRED ON AN APPROACH OF AN INTERSECTION, THE LOOPS USED FOR VOLUME DENSITY AND INTERSECTION TIMING SHALL ALSO BE USED AS SYSTEM DETECTORS. EACH ONE OF THESE TYPE OF LOOPS REQUIRES A SEPARATE TWO CONDUCTOR NO. 14 TWISTED SHIELDED CABLE AND A SEPARATE INDUCTIVE LOOP DETECTOR WHEN NEW CONTROLLERS ARE UTILIZED. THE DESIGNER SHALL LABEL THESE TYPES OF LOOPS AS "INTERSECTION AND SAMPLING (SYSTEM) DETECTORS" ON THE SIGNAL LAYOUT, THE INTERCONNECT PLAN AND THE SYSTEM CABLE PLAN. WHEN AN EXISTING CONTROLLER IS UTILIZED FOR THIS TYPE OF DETECTION, THE PAY ITEM "INDUCTIVE LOOP DETECTOR WITH SYSTEM OUTPUT" SHOULD BE USED.

PLACEMENT OF DETECTORS

THE FOLLOWING FIGURES REPRESENT THE MOST COMMON DETECTOR LOOP LOCATIONS AND SIZES. ADJUSTMENTS WILL BE NECESSARY FOR SPECIFIC GEOMETRIC CONSIDERATIONS.

LOCATIONS AND DEMENSIONS OF DETECTOR LOOPS ARE REQUIRED ON ALL SIGNAL LAYOUT PLAN SHEETS.

"FAR OUT" DETECTION REFERS TO LOCKING, PRESENCE TYPE DETECTION LOCATED IN THRU LANES, RIGHT TURN LANES, AND RIGHT TURN LANE TAPER AREAS (IF APPLICABLE), USUALLY 250' (75 m) IN ADVANCE OF STOP BARS. "UPTIGHT" DETECTION REFERS TO NON-LOCKING PRESENCE TYPE DETECTION LOCATED IN ALL LANES AND 10'-15' (3.0 m-4.5 m) BEHIND THE CROSSING STREET'S EDGE OF PAVEMENT EXTENDED.

ALL DETAILS AND NOTES SHOWN ARE FROM THE I.D.O.T. DISTRICT 1 TRAFFIC SIGNAL DESIGN GUIDELINES DATED JANUARY 1995

THIS DRAWING HAS BEEN PREPARED TO ASSIST THE RESIDENT ENGINEER FOR ALL ROADWAY RESURFACING OR S.M.A.R.T. PROJECTS WHERE THE DIMENSIONS ARE NOT SHOWN ON THE PLANS AND THE FINAL LOCATIONS FOR CROSSWALKS OR STOP BARS ARE NOT DETERMINED.

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	PLOT DATE = 9/1/2023	DATE	-	9/1/2023	REVISED	-	

STRAIGHT SAW

(TYP.)

DETAIL 1

N.T.S.

DESIGNED

HECKED -

R.K.F.

DRAWN

CUTS TO HEAVY

STATE OF ILLINOIS **DEPARTMENT OF TRANSPORTATION**

STATE OF ILLINOIS

DEPARTMENT OF TRANSPORTATION

DISTRICT 1 - DETECTOR LOOP INSTALLATION	F.A.U. RTE.	SECTION	COUNTY	TOTAL SHEETS	SHEET NO.
DETAILS FOR ROADWAY RESURFACING	1379	21-00073-00-RS	DUPAGE	40	39
			CONTRA	CT NO.	61J85
SHEET NO. 39 OF 40 SHEETS STA. TO STA.		TILINOIS FED AT	D PROJECT		

DISTRICT 1 - DETECTOR LOOP INSTALLATION DETAILS FOR ROADWAY RESURFACING SCALE: NONE SHEET 1 SHEETS STA.

SCALE: \$N.T.S.\$ SHE

CONTRACT NO TS-07

